

BID SET

PORT GAMBLE BAY CLEANUP

POPE RESOURCES LP / OPG PROPERTIES LLC

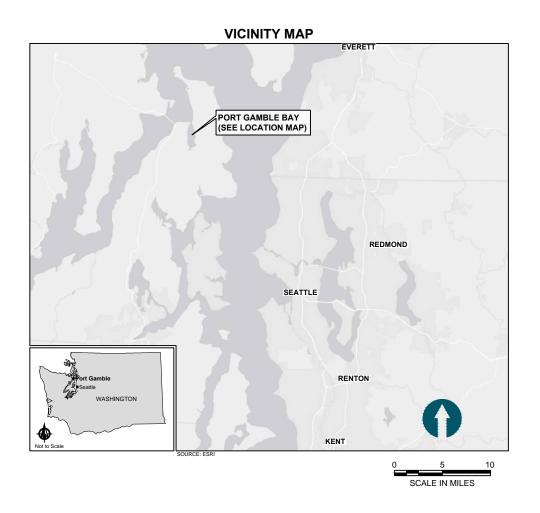

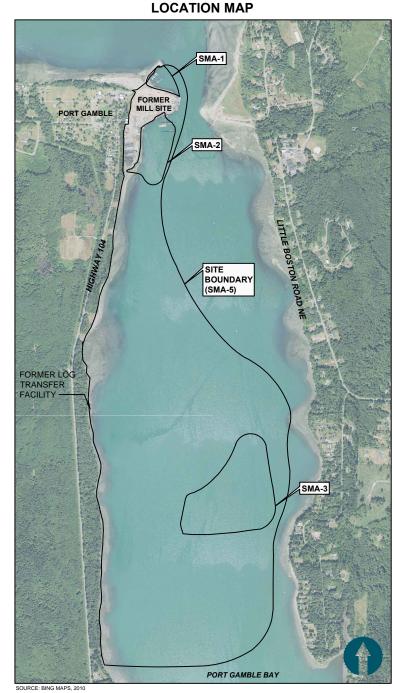





ISSUED FOR CONSTRUCTION

APPERE A					REVISIONS	
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RAWN BY: C. HEWETT

PORT GAMBLE BAY CLEANUP

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COVER SHEET

SHEET NO. 1 OF 27

POPE RESOURCES LP / OPG PROPERTIES LLC

SMA-2 DREDGE CONTROL POINTS

SMA-1 DREDGE CONTROL POINTS										
SMA-1 DREDGE CONTROL POINTS SMA-1 DREDGE CONTROL POINTS										
POINT #	NORTHING	EASTING	POINT#	NORTHING	EASTING					
1	317099.68	1211886.63	46	317270.21	1211534.74					
2	317115.89	1211839.81	47	317330.04	1211474.92					
3	317159.34	1211769.01	48	317380.49	1211525.37					
4	317176.75	1211721.62	49	317374.13	1211531.74	l				
5	317213.02	1211597.43	50	317381.22	1211538.83	l				
6	317208.44	1211560.17	51	317377.96	1211542.08	l				
7	317298.13	1211277.63	52	317349.81	1211522.77	l				
8	317328.17	1211269.57	53	317303.22	1211529.71	l				
9	317357,24	1211247,88	54	317284.37	1211548,91	l				
10	317427.43	1211252.42	55	317333.22	1211471.74	l				
11	317514.41	1211283.07	56	317389.86	1211415.09					
12	317545.36	1211312.18	57	317437.14	1211462.37					
13	317576.31	1211341.28	58	317380.49	1211519.01					
14	317589.39	1211343.73	59	317386.86	1211531.74					
15	317636,94	1211390.35	60	317446,68	1211471.91					
16	317640.39	1211402.29	61	317528.62	1211573.80					
17	317699.26	1211462.31	62	317478.77	1211623.65	l				
18	317728.82	1211493.48	63	317287.63	1211552.17	l				
19	317758.99	1211524.87	64	317305.38	1211533.94	l				
20	317718.25	1211557.57	65	317348.72	1211527.48	l				
21	317695.97	1211587.68	66	317375.98	1211546.18					
22	317707.17	1211608.83	67	317360.84	1211561.32					
23	317706,50	1211613.95	68	317358,72	1211565.57	l				
24	317704.25	1211613.93	69	317329.57	1211594.12	l				
25	317682,55	1211588.88	70	317362.96	1211563.44					
26	317665.04	1211545.22	71	317385.46	1211540.95					
27	317609.68	1211473.38	72	317473.47	1211628.96					
28	317585.05	1211448 63	73	317418 93	1211683.50					
29	317543.83	1211397.68	74	317392.03	1211656.59	l				
30	317506.28	1211370.44	75	317424.07	1211624.56	l				
31	317464 34	1211348 66	76	317330.93	1211595 48	l				
32	317434.83	1211340.84	77	317359.78	1211566.63	l				
33	317417.08	1211342 25	78	317417.71	1211624.56	l				
34	317395.08	1211353.17	79	317388.85	1211653.41	l				
35	317367.32	1211383.29	80	317421.05	1211685.62					
36	317364.24	1211389.47	81	317421.63	1211631.08					
37	317362.90	1211402.10	82	317486.20	1211631.08					
38	317302.90	1211450,50	83	317535.24	1211582.03					
39	317312.62	1211450.95	84	317551.82	1211603.13					
40	317303.69	1211509.70	85	317432.38	1211696.95					
41	317245.43	1211509.70	86	317436.65	1211701.23	1				
42	317245.43	1211697.23	87	317555.83	1211701.23					
43	317202.00	1211751.87	88	317555.63	1211640.09					
			89	317581.97						
44	317169.80 317136.80	1211812.59	90	317495,80	1211728.34					

	REDGE CONTR			REDGE CONTR			REDGE CONTR	
POINT#	NORTHING	EASTING	POINT #	NORTHING	EASTING	POINT#	NORTHING	EASTING
1001	316669.16	1211637.49	1055	316027.55	1211292.89	1108	316419.83	1211240.69
1002	316671.08	1211620.32	1056	316027.55	1211309.89	1109	316411.09	1211233.91
1003	316669.50	1211611.47	1057	315960.43	1211309.89	1110	316391.04	1211225.08
1004	316662.07	1211598.15	1058	315960.43	1211241.10	1111	316376.95	1211225.08
1005	316658.98	1211590.07	1059	316003.21	1211234.39	1112	316357.03	1211230.35
1006	316666.90	1211557.76	1060	316030.55	1211231.73	1113	316245.88	1211277.96
1007	316665.23	1211551.48	1061	316089.55	1211232.06	1114	316221.19	1211280.68
1008	316636.84	1211500.79	1062	316089.55	1211266.89	1115	316203.48	1211276.52
1009	316627,07	1211489,69	1063	316240,47	1211280,28	1116	316180,61	1211277,79
1010	316614.24	1211465.80	1064	316170.23	1211310.20	1117	316183.99	1211260.89
1011	316610.77	1211461.61	1065	316160.52	1211315.78	1118	316192.09	1211260.89
1012	316615.01	1211458.97	1066	316142.65	1211331.89	1119	316204.12	1211207.39
1013	316618.49	1211463.16	1067	316050.01	1211331.89	1120	316202.81	1211190.00
1014	316623.87	1211472.43	1068	316050.01	1211320.39	1121	316191.00	1211174.46
1015	316631,31	1211487.05	1069	316036,55	1211309.89	1122	316174.74	1211166.62
1016	316641.09	1211498.14	1070	316036.55	1211301.89	1123	316094.24	1211166.76
1017	316669.47	1211548.84	1071	316177.55	1211301.89	1124	316080.00	1211169.85
1018	316671.14	1211555.12	1072	316177.55	1211281.59	1125	316067.95	1211178.05
1019	316663.23	1211587.43	1073	316132,74	1211340.89	1126	316062,85	1211187.85
1020	316666.32	1211595.51	1074	316132.88	1211367.89	1127	316066.84	1211195.38
1021	316673.74	1211608.83	1075	316041.04	1211367.89	1128	316071.47	1211201.82
1022	316675.32	1211617.68	1076	316041.60	1211340.89	1129	316072.40	1211214.54
1024	316609.14	1211644.89	1077	316132.89	1211373.89	1130	316059.69	1211219.31
1025	316606.92	1211645.76	1078	316035.03	1211373.89	1131	316043.07	1211221.76
1026	316595.74	1211626.95	1079	316030.51	1211329.91	1132	316030.60	1211222,23
1027	316598.29	1211625.44	1080	316030.51	1211407.41	1133	316032.29	1211210.70
1028	316585.86	1211603.17	1081	315880.68	1211403.97	1134	315968.68	1211215.02
1029	316582.71	1211605.03	1082	315883.01	1211320.39	1135	315999.63	1211160.78
1030	316549.81	1211549.68	1083	316018.31	1211320.39	1136	315963.03	1211156.24
1031	316554.45	1211547.07	1084	315957.43	1211238.33	1137	315842.10	1211177.10
1032	316552.09	1211543.06	1085	315957.43	1211306.89	1138	315811.81	1211174.87
1033	316547.48	1211545.77	1086	315883.18	1211306.89	1139	315788.16	1211161.40
1034	316541.77	1211538.69	1087	315884.56	1211267.55	1140	315758.71	1211153.38
1035	316501.97	1211534.30	1088	315919.75	1211249.38	1141	315717.98	1211150.78
1036	316535.25	1211508.59	1089	315872.13	1211333.70	1142	315694.34	1211142.83
1037	316548.49	1211529.92	1090	315871.33	1211362.69	1143	315671.24	1211129.30
1038	316523.33	1211489.37	1091	315773.87	1211359.98	1144	315633.06	1211095.68
1039	316469.76	1211530,75	1092	315774,67	1211330.99	1145	315578,97	1211065,42
1040	316428.64	1211469.49	1093	315877.16	1211368.85	1146	315566.48	1211060.03
1041	316489.97	1211435.60	1094	315876.19	1211403.84	1147	315495.89	1211045.40
1042	316486.01	1211429.22	1095	315772.73	1211400.96	1148	315476.00	1211034.74
1043	316424.43	1211463.24	1096	315773.70	1211365.98	1149	315467.32	1211026.62
1044	316371.57	1211384.48	1097	316627.20	1211446.53	1150	315487.68	1210871.32
1045	316383.08	1211322.17	1098	316593,86	1211431.10	1151	315488.52	1210864,96
1046	316396.71	1211306.10	1099	316553.58	1211396.37	1152	315587.33	1210968.37
1047	316436.40	1211375.54	1100	316540.53	1211395.39	1153	315638.91	1211046.90
1048	316447.32	1211366.86	1101	316508.67	1211333.88	1154	315583.37	1210971.46
1049	316168,55	1211217,59	1102	316493,17	1211316.15	1155	315631,97	1211047,38
1050	316168.55	1211260.89	1103	316470.55	1211308.70	1156	315717.62	1211104.54
1051	316095.55	1211260.89	1104	316453.80	1211273.07	1157	316391.60	1211153.25
1052	316095.34	1211217.96	1105	316446.32	1211262.18	1158	316423.33	1211169.35
1053	316168.55	1211266.89	1106	316435.28	1211253.29	1159	316598.19	1211391.70
1054	316168.55	1211292.89	1107	316424.99	1211249.17			•
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SMA-1 CAPPING CONTROL POINTS

SMA-1 (CAPPING CONTR	ROL POINTS	SMA-1 C	APPING CONTR	OL POINTS
POINT#	NORTHING	EASTING	POINT#	NORTHING	EASTING
2001	317058.09	1211948.93	2037	317161.43	1211842.57
2002	317079.63	1211911.05	2038	317182.83	1211808.00
2003	317073.23	1211907.76	2039	317202.80	1211747.20
2004	317101.05	1211827.46	2040	317205.28	1211709.28
2005	317078.82	1211817.39	2041	317220.51	1211668.36
2006	317178.42	1211539.74	2042	317221.35	1211626.65
2007	317206.50	1211432.00	2043	317241.16	1211557.46
2008	317244.01	1211345.44	2044	317245.81	1211542.71
2009	317271,73	1211291.09	2045	317246,34	1211516,66
2010	317291.43	1211269.06	2046	317243.99	1211513.13
2011	317323.68	1211259.88	2047	317364.17	1211389.40
2012	317354.77	1211238.28	2048	317372.34	1211385.66
2013	317428.97	1211242.06	2049	317395.68	1211358.12
2014	317519.90	1211272.86	2050	317415.63	1211347.17
2015	317579.63	1211327.93	2051	317429.50	1211344.38
2016	317596.96	1211335.55	2052	317452.46	1211348.50
2017	317647.97	1211380.92	2053	317504.50	1211373.01
2018	317649.58	1211396.07	2054	317543.25	1211401.50
2019	317696.09	1211442,49	2055	317575,69	1211439,16
2020	317762.72	1211509.05	2056	317663.87	1211545.49
2021	317770.34	1211525.71	2057	317681.84	1211589.57
2022	317725.70	1211562.31	2058	317702.85	1211623.05
2023	317704.30	1211586.64	2059	317277.92	1211550.08
2024	317716.53	1211605.12	2060	317384.22	1211655.78
2025	317710.57	1211616.94	2061	317446.13	1211716,87
2026	317565.28	1211739.46	2062	317496.17	1211730.73
2027	317454.60	1211811.04	2063	317586.32	1211641.20
2028	317336.29	1211869.16	2064	317558.71	1211602.29
2029	317161.49	1211928.06	2065	317553.57	1211601.73
2030	317079.01	1211891.07	2066	317538.51	1211582.50
2031	317087.06	1211894.10	2067	317537.71	1211567.29
2032	317164.60	1211772.04	2068	317458.67	1211462.50
2033	317225.01	1211552.77	2069	317437.35	1211460.26
2034	317077.94	1211915.22	2070	317413.42	1211438.00
2035	317108.35	1211897.35	2071	317398.15	1211414.85
2036	317135.15	1211874.75	2072	317375.12	1211393.88

SMA-2 CAPPING	CONITROL	DOINTE
SIVIA-Z CAPPING	CONTROL	PUINTS


SMA-2 0	CAPPING CONTR	ROL POINTS	SMA-2 C	CAPPING CONTR	OL POINTS	SMA-2 0	APPING CONTR	OL POINTS
POINT#	NORTHING	EASTING	POINT #	NORTHING	EASTING	POINT#	NORTHING	EASTING
3001	316654.26	1211695.74	3056	315565.76	1210879.14	3111	316139.49	1211437.75
3002	316612.04	1211669.29	3057	315574.39	1210882.60	3112	316133.08	1211421.01
3003	316591.26	1211635.15	3058	315649.95	1210984.70	3113	315861.90	1211258.35
3004	316565.23	1211616.00	3059	315672.46	1211004.87	3114	315864.08	1211303.01
3005	316523.91	1211565.03	3060	315673.14	1211015.78	3115	315854.96	1211313.80
3006	316499.32	1211561.93	3061	315732.85	1211059.57	3116	315771.88	1211310.68
3007	316461.45	1211539.63	3062	315924.23	1211072.04	3117	315761.68	1211316.24
3008	316438.22	1211503.78	3063	315929.17	1211067.11	3118	315756.98	1211325.34
3009	316406,55	1211479.33	3064	315954.75	1211066.69	3119	315690.47	1211340.40
3010	316410.64	1211469.25	3065	315962.79	1211073.34	3120	315636.67	1211336.90
3011	316357.27	1211387.26	3066	316265.73	1211095.75	3121	315528.09	1211308.75
3012	316359.91	1211312.09	3067	316402.79	1211105.34	3122	315493.35	1211273.72
3013	316377.00	1211276.74	3068	316449.05	1211130.19	3123	315481.52	1211236.82
3014	316396.77	1211263.77	3069	316722.77	1211519.49	3124	315535.02	1211253.10
3015	316397.86	1211246.05	3070	316719.31	1211533.60	3125	315564.03	1211263.05
3016	316410.07	1211238.76	3071	316713.19	1211541.38	3126	315619.18	1211285.18
3017	316388.85	1211229.33	3072	316734.54	1211604.29	3127	315667.09	1211292.23
3018	316145.10	1211334.74	3073	316721.66	1211608.48	3128	315697.05	1211292.08
3019	316132,99	1211404.44	3074	316729.07	1211633.22	3129	315789,80	1211270,39
3020	316097.84	1211395.75	3075	316680.59	1211650.64	3130	315825.86	1211265.15
3021	316030.44	1211410.69	3076	316672.03	1211637.14	3131	315846.37	1211260.21
3022	315880.13	1211408.29	3077	316635.00	1211641.70	3132	316517.88	1211737.25
3023	315876.17	1211404.53	3078	316654.50	1211686.50	3133	316433.69	1211740.41
3024	315771.79	1211402.00	3079	316676.66	1211644.43	3134	316421.33	1211737.00
3025	315766,54	1211365.78	3080	316623.18	1211453.74	3135	316355.96	1211691.40
3026	315771.65	1211359.92	3081	316593.08	1211394.88	3136	316260.28	1211673.70
3027	315766.96	1211326.64	3082	316419.03	1211173.90	3137	316194.04	1211701.17
3028	315772.72	1211320.75	3083	316389.61	1211159.13	3138	316164.74	1211708.00
3029	315865.28	1211323.98	3084	315717.07	1211110.76	3139	315708.53	1211583.39
3030	315865.16	1211316.73	3085	315642.41	1211056.37	3140	315583.16	1211498.49
3031	315874.27	1211306.78	3086	315631.97	1211047.38	3141	316554.05	1211733.22
3032	315871.04	1211264.50	3087	315583.01	1210971.10	3142	316514.05	1211789.11
3033	315876.53	1211253.53	3088	315540.49	1210926.59	3143	316476.64	1211821.08
3034	315911.95	1211227.31	3089	315483.95	1210860.53	3144	316412.15	1211855.43
3035	315930.59	1211218.74	3090	315476.83	1210912.01	3145	316301.59	1211855.66
3036	315962.77	1211215.53	3091	316670.92	1211617.69	3146	316219.56	1211833.10
3037	315990.72	1211164.56	3092	316658.54	1211591.82	3147	316050.31	1211798.34
3038	315962,44	1211160.82	3093	316667.27	1211555.68	3148	315838,81	1211744.48
3039	315842.97	1211182.28	3094	316636.84	1211500.79	3149	315330.05	1211581.94
3040	315810.28	1211179.68	3095	316610.77	1211461.61	3150	315286.75	1211556.20
3041	315786.03	1211166.19	3096	316547.33	1211400.02	3151	315238.04	1211479.00
3042	315753.22	1211157.96	3097	316536.99	1211397.59	3152	315219.09	1211399.08
3043	315715.21	1211153.62	3098	316488.32	1211323.06	3153	315239.39	1211302.92
3044	315692.99	1211146.83	3099	316468.45	1211310.71	3154	315298.92	1211237.90
3045	315667.33	1211132.01	3100	316440.01	1211264.56	3155	315377.09	1211190.97
3046	315626.64	1211097.39	3101	316410.38	1211248.24	3156	315363.93	1211158.18
3047	315589.07	1211076.52	3102	316357.98	1211203.02	3157	315425.74	1211165.86
3048	315565,75	1211065,23	3103	316335.00	1211194.92	3158	315435,19	1211176,11
3049	315494.15	1211050.11	3104	316200.77	1211186.18	3159	315450.79	1211216.77
3050	315472.56	1211038.42	3105	316182.91	1211174.98	3160	316204.27	1211627.00
3051	315462.70	1211028.55	3106	316084.44	1211174.35	3161	316143.42	1211566.16
3052	315488.53	1210830.45	3107	316062.77	1211187.13	3162	316143.42	1211687.84
3053	315492.89	1210830.98	3108	315976.75	1211190.04	3163	316082.58	1211627.00
3054	315499.08	1210817.99	3109	316381.54	1211485.59			· · · · · · · · · · · · · · · · · · ·
3055	315509.96	1210818.57	3110	316170.47	1211451.40	1		
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ABBRV	ABBREVIATION
APPROX.	APPROXIMATE/APPROXIMATELY
BLDG	BUILDING
BMP	BEST MANAGEMENT PRACTICES
CONC	CONCRETE
CONT	CONTINUED OR CONTINUOUS
СР	CONTROL POINT (SURVEYED)
CY	CUBIC YARD
DWG	DRAWING
E	EAST
EL, ELEV	ELEVATION
EX	EXISTING
FT	FOOT OR FEET
IN	INCH OR INCHES
MAX	MAXIMUM
MH	MANHOLE, MAINTENANCE HOLE
MIN	MINIMUM
MISC	MISCELLANEOUS
MHHW	MEAN HIGHER HIGH WATER
MLLW	MEAN LOWER LOW WATER
N	NORTH
NAD	NORTH AMERICAN DATUM
NAV/D	NORTH AMERICAN VERTICAL
NAVD	DATUM
NO.	NUMBER
OC	ON CENTER
OHP	OVERHEAD POWER
PR/OPG	POPE RESOURCES/OPG PROPERTIES LLC
ROW	RIGHT OF WAY
S	SOUTH
SD	STORM DRAIN
SF	SQUARE FOOT OR FEET
SHT	SHEET
SMA	SEDIMENT MANAGEMENT AREA
SPEC	SPECIFICATION
STA	STATION
STD	STANDARD
STRUCT	STRUCTURE, STRUCTURAL
TESC	TEMPORARY EROSION AND SEDIMENT CONTROL
TYP	TYPICAL
W	WEST
	WASHINGTON STATE
WSDOT	DEPARTMENT OF
	TRANSPORTATION

ABBREVIATIONS

DETAIL AND SECTION REFERENCING:

45 317136.80 1211852.81 90 317449.56 1211714.15

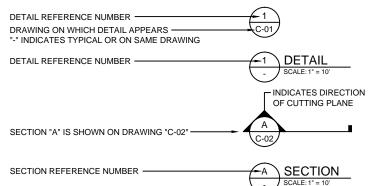

GENERAL SURVEY NOTES

- 1. HORIZONTAL DATUM: WASHINGTON STATE PLANE NORTH ZONE, NAD 83, U.S. FEET.
- 2. VERTICAL DATUM: MEAN LOWER LOW WATER (MLLW).
- 3. UPLAND SURVEY BY TRIAD ASSOCIATES, DATED JULY, 2012. DATUM CHANGED FROM NAVD88 TO MLLW WITH THE FOLLOWING EQUATION, NAVD88 \pm 2.12 FEET = MLLW. BATHYMETRY BY ETRAC, DATED AUGUST 27, 2014, AND ECOLOGY, DATED 2014.
- 4. THE ABOVE SURVEYS WERE MERGED BY ANCHOR QEA TO PROVIDE A CONTINUOUS EXISTING ELEVATIONS DATA SET.
- 5. MEAN HIGHER HIGH WATER IS AT ELEVATION 10.30 FEET MLLW

ISSUED FOR CONSTRUCTION

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No lic	REV	DATE	BY	APP'D	DESCRIPTION	DESIGNED BY: R. PICKERING
AN US						DRAWN BY: C. HEWETT
1 E						CHECKED BY: J. LAPLANTE
~ E						APPROVED BY: J. LAPLANTE
						SCALE: N/A
6						DATE: JULY 2015

PORT GAMBLE BAY CLEANUP


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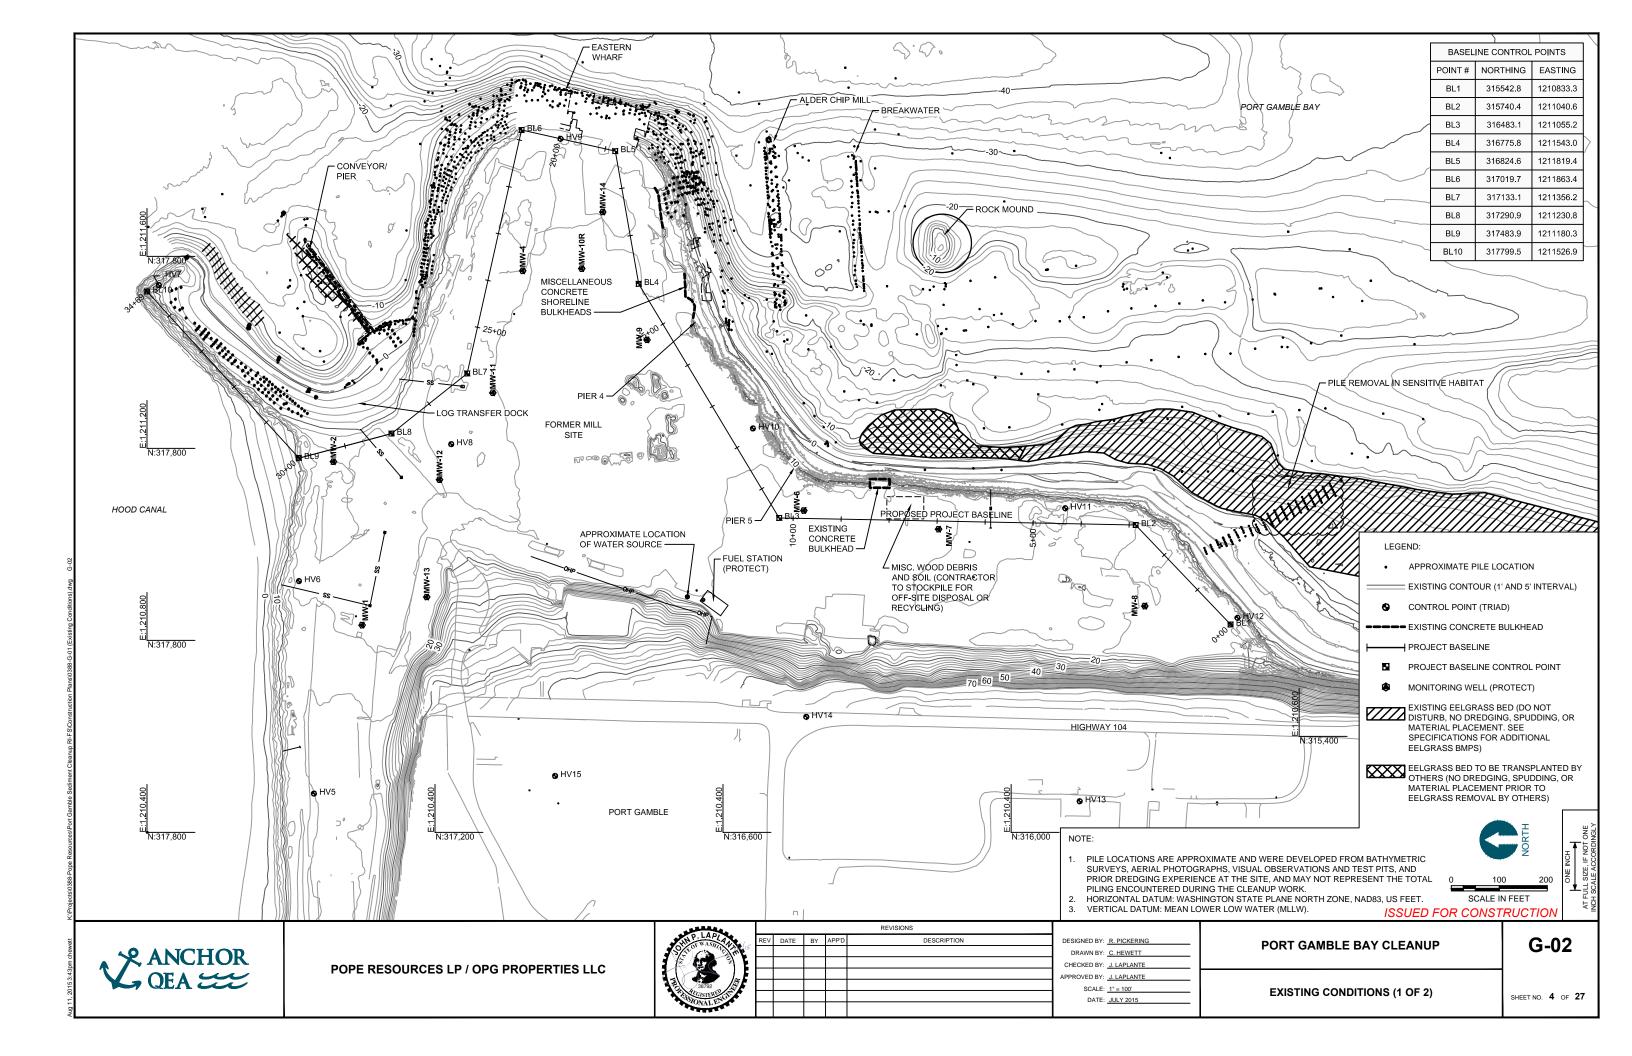
GENERAL NOTES, ABBREVIATIONS, AND CONTROL


SHEET NO. 2 OF 27


POPE RESOURCES LP / OPG PROPERTIES LLC


ECKED BY: J. LAPLANTE ROVED BY: J. LAPLANTE SCALE: N/A




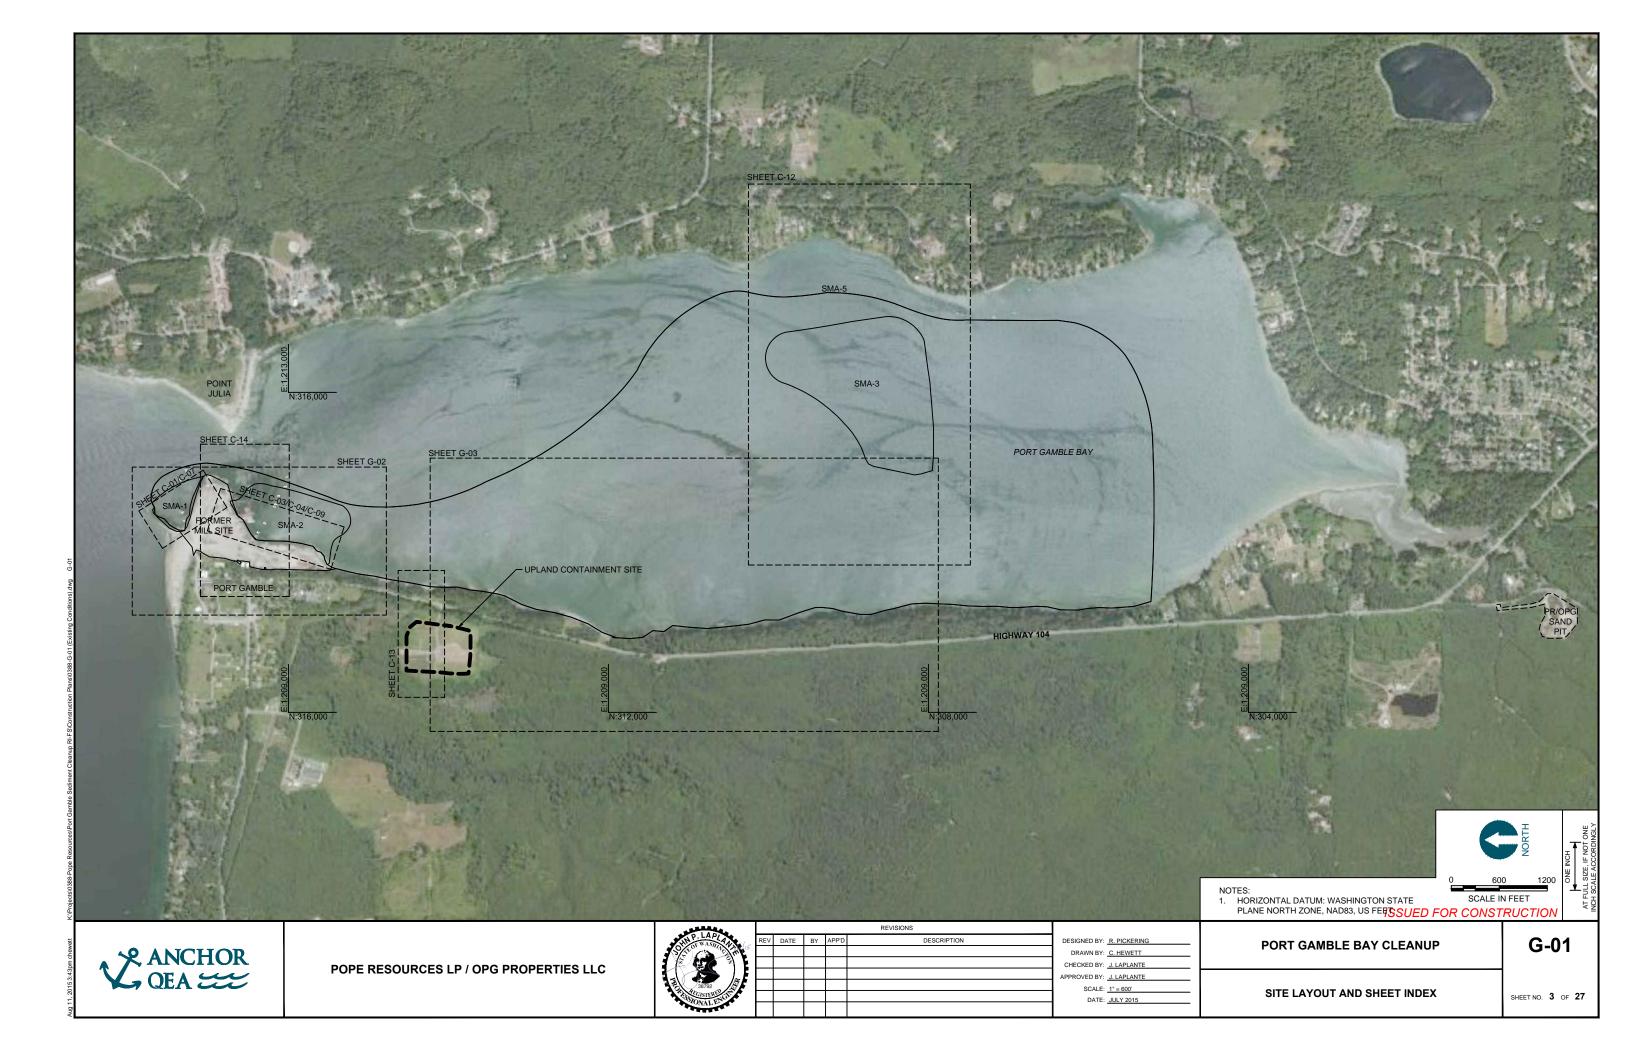


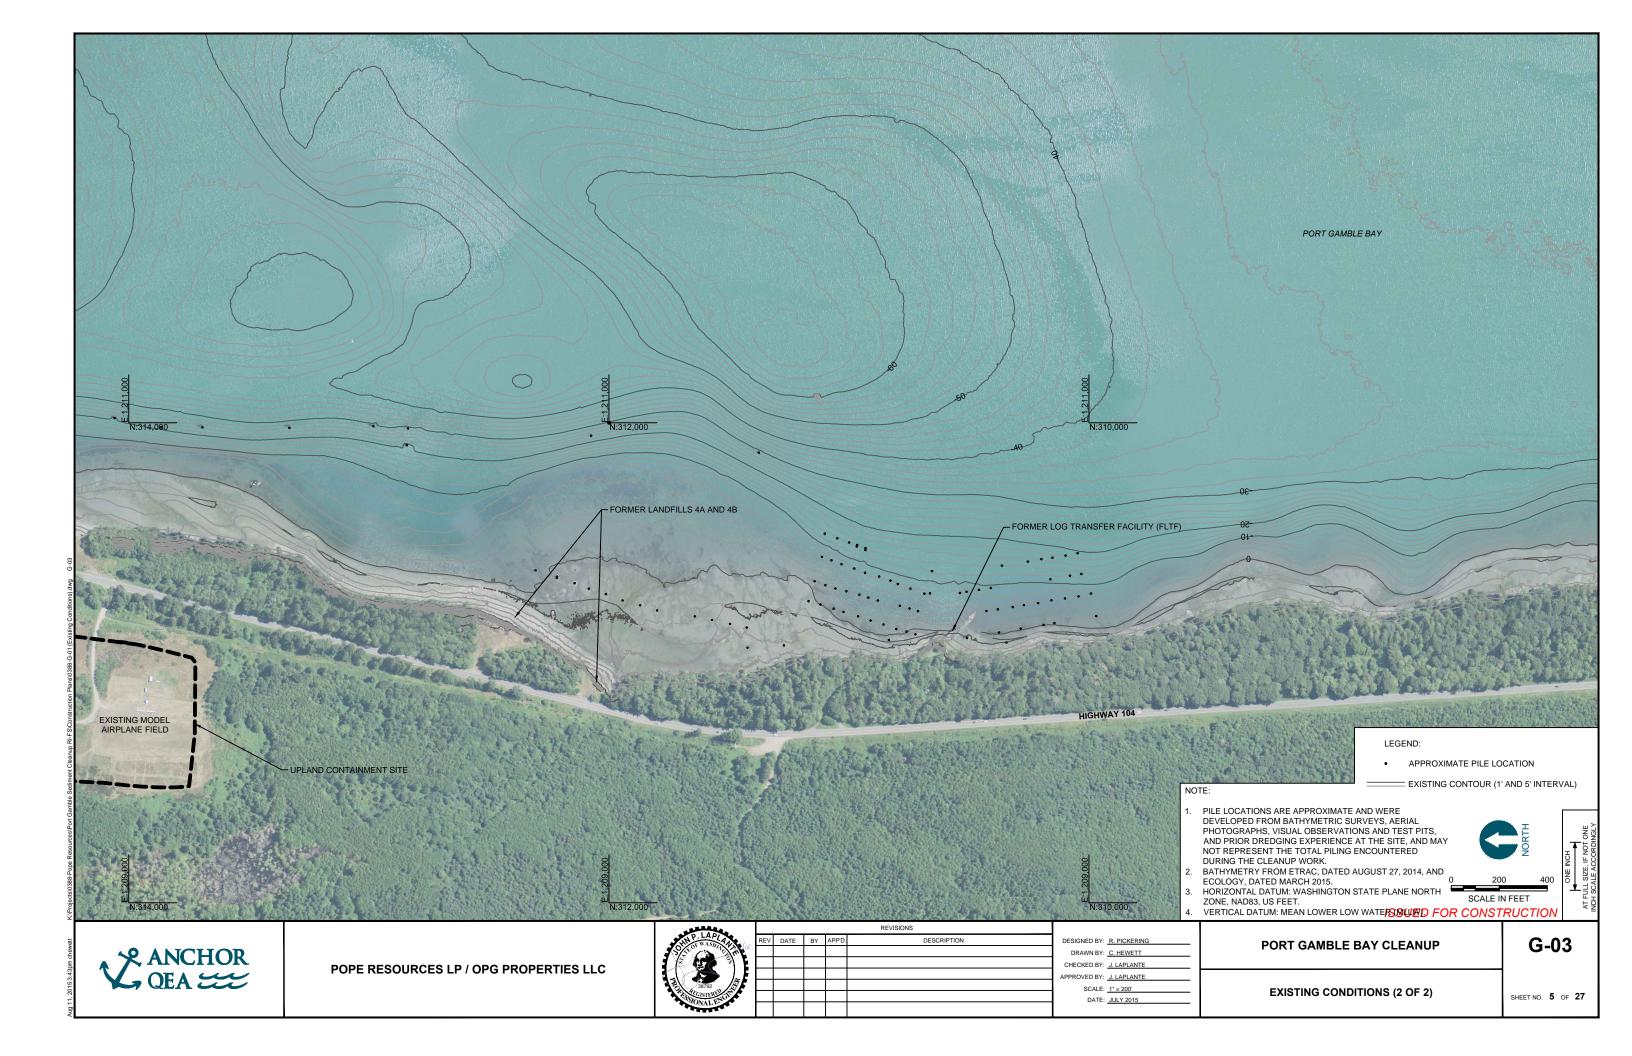


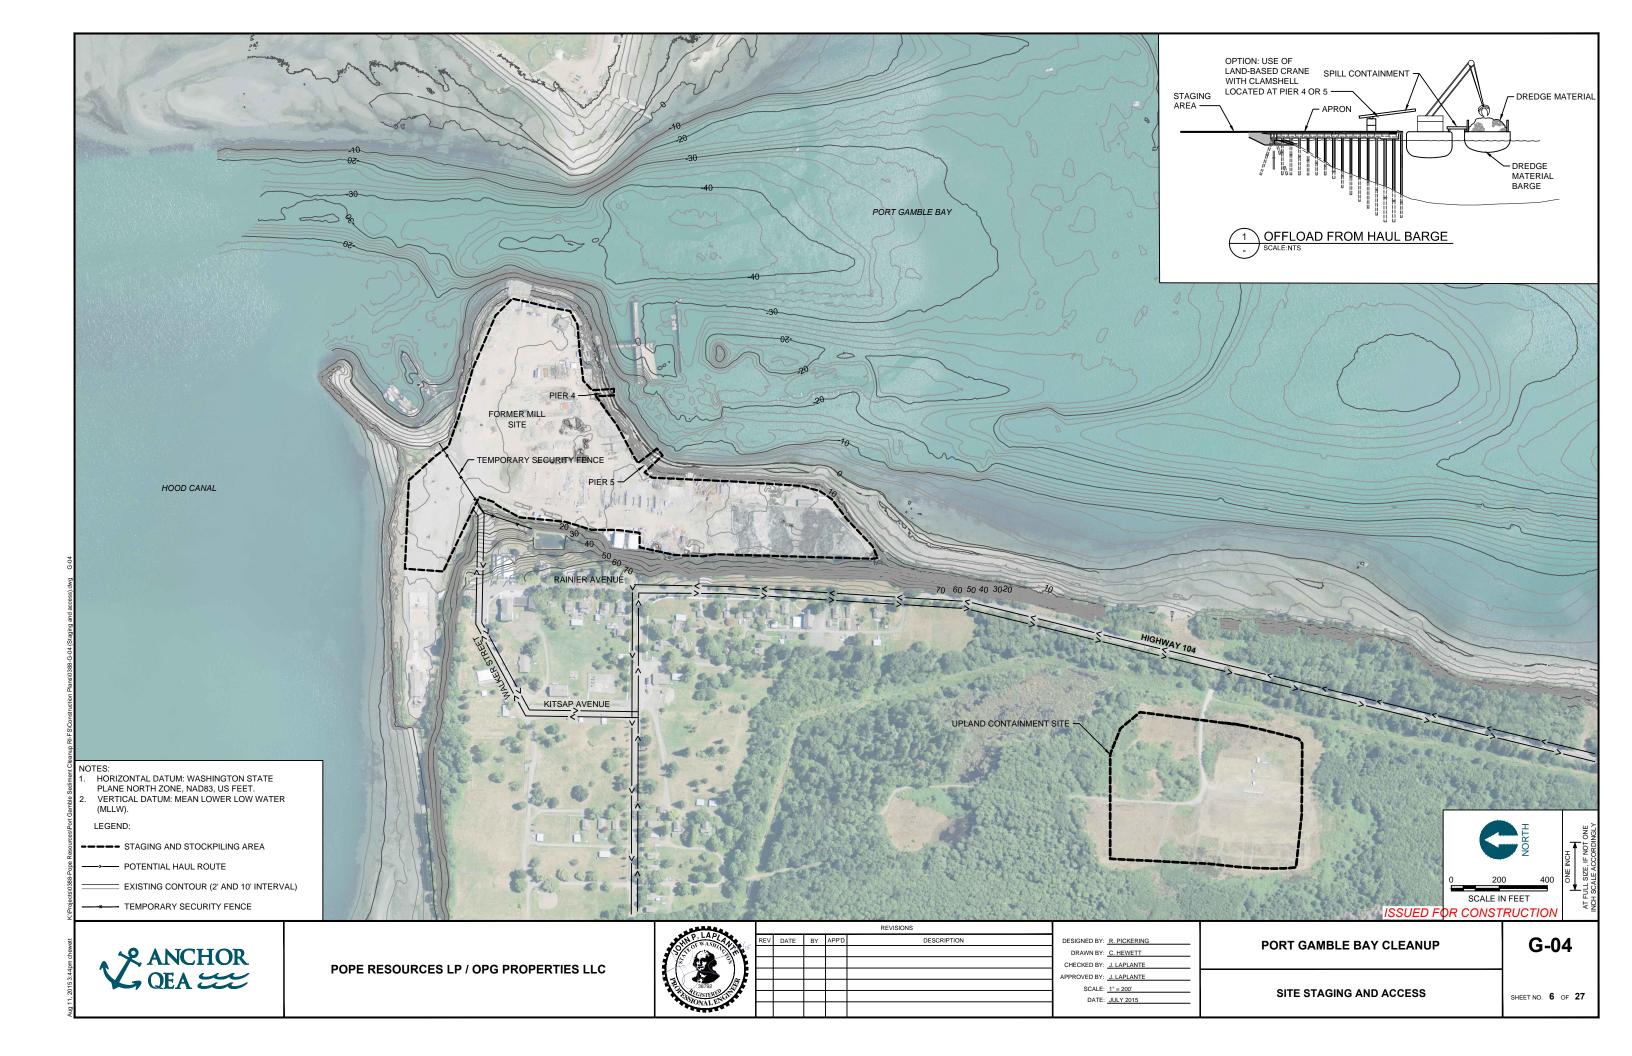


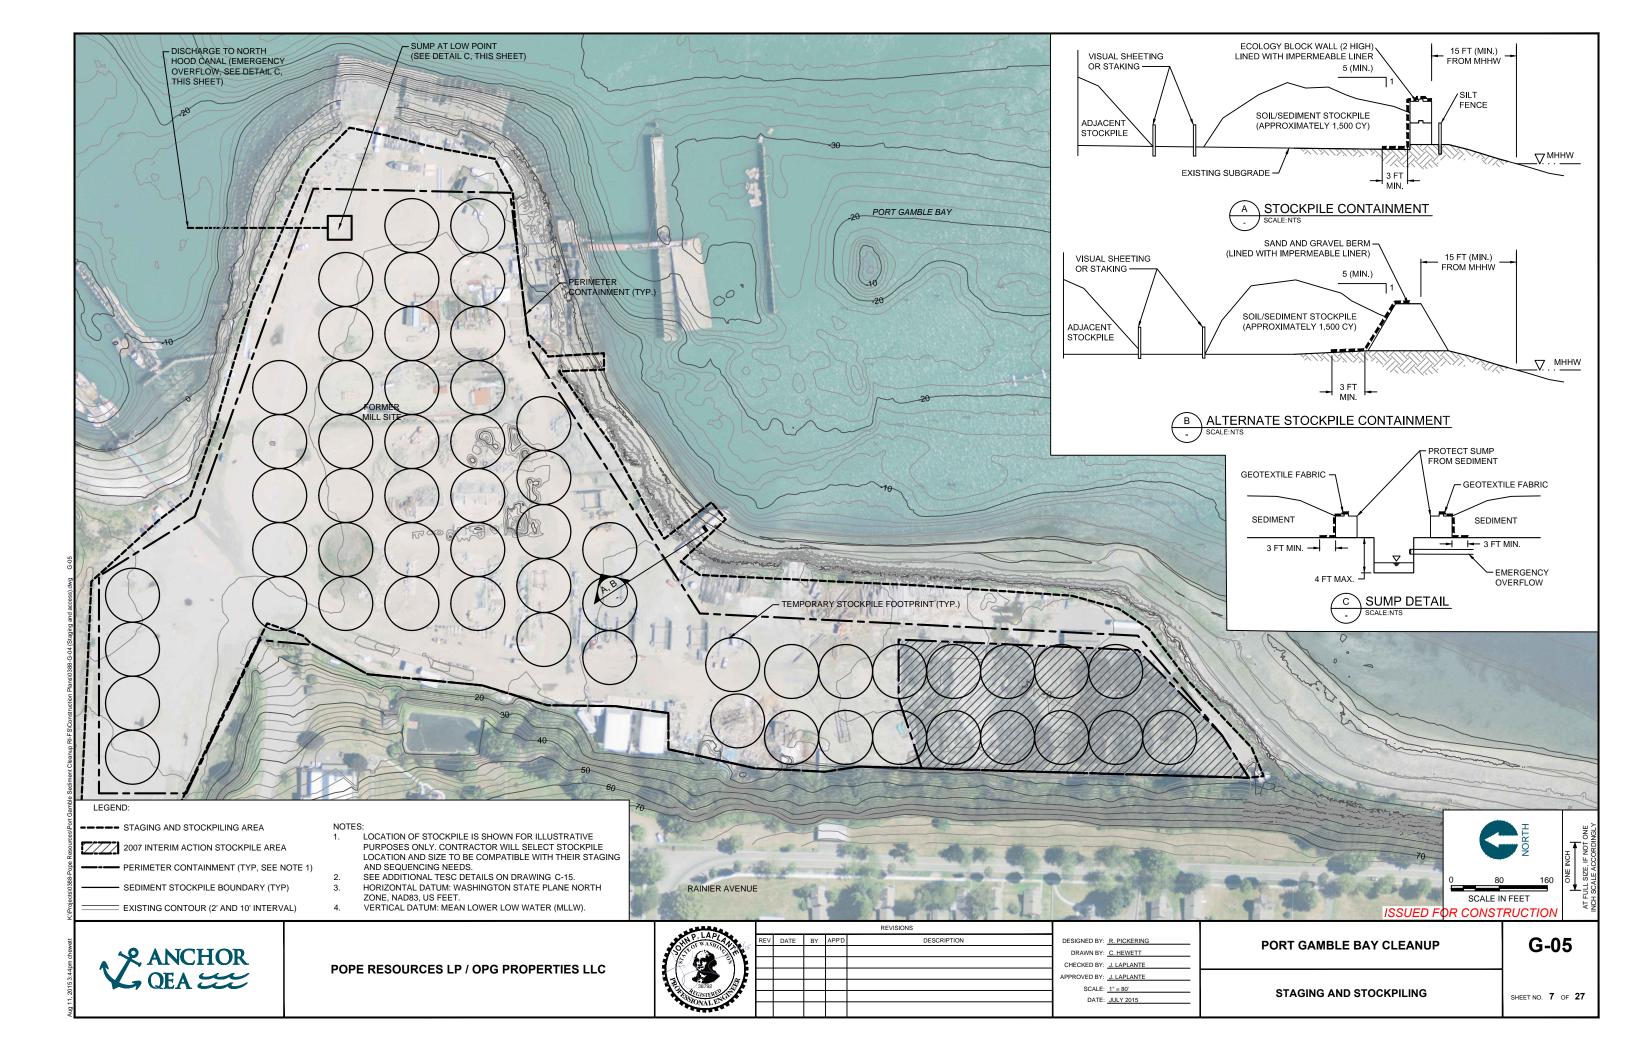


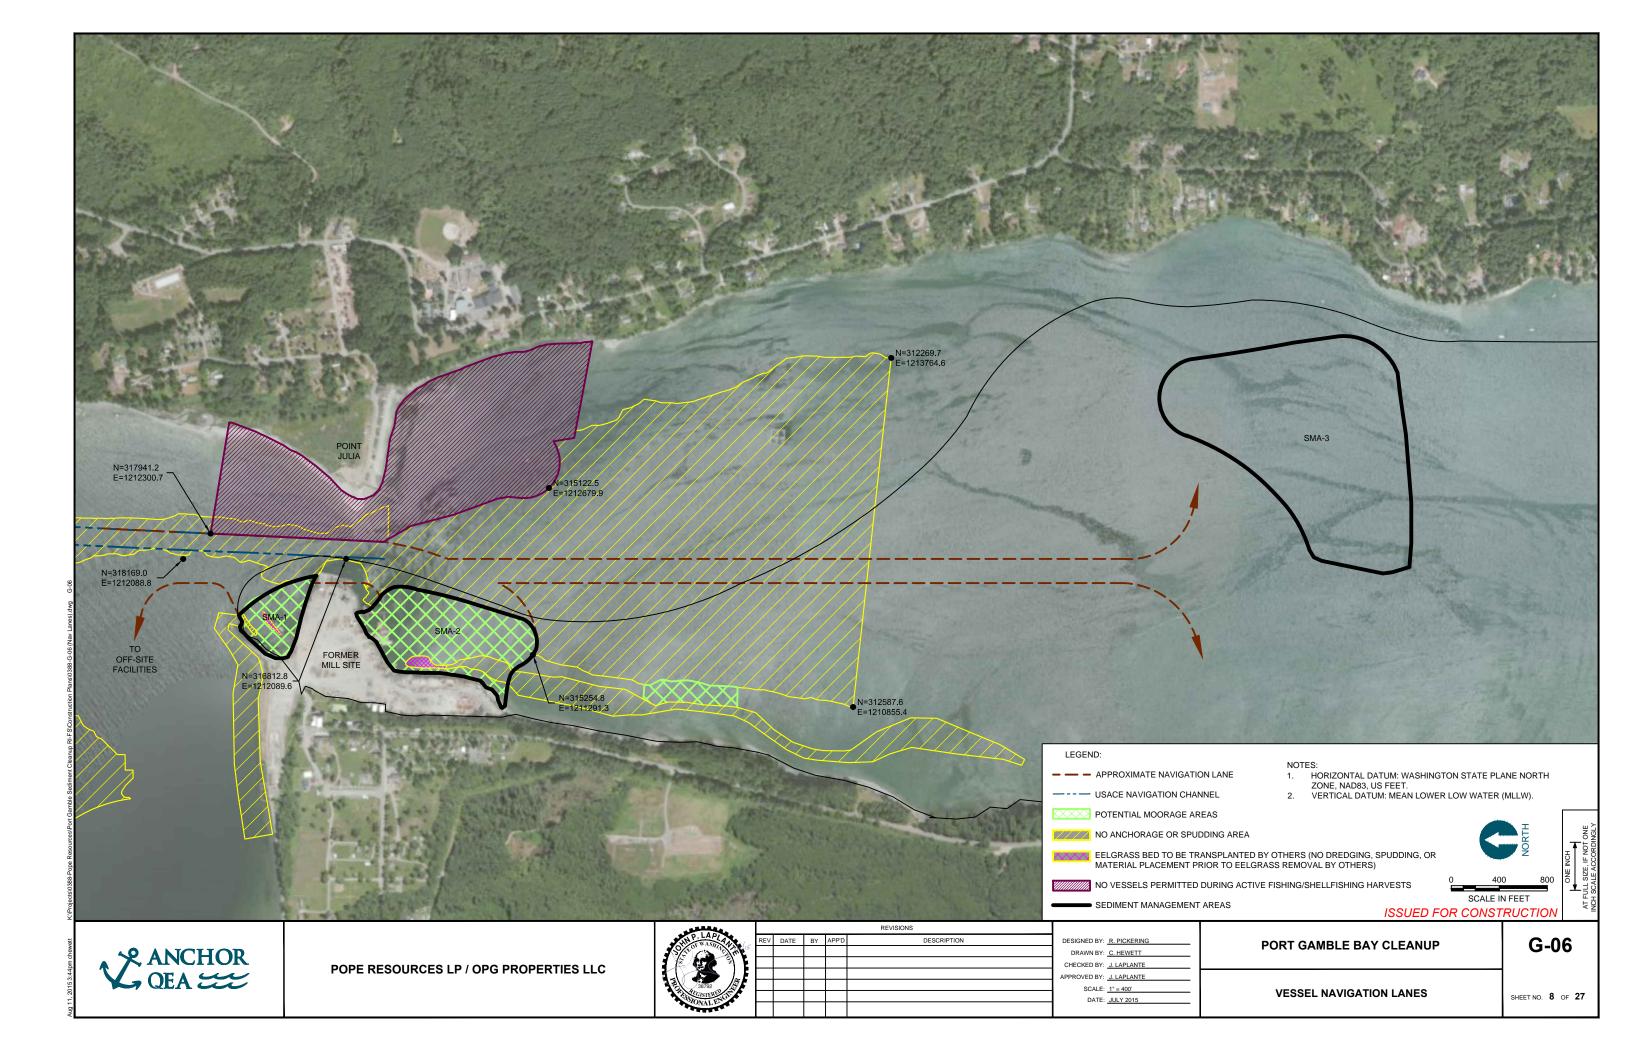


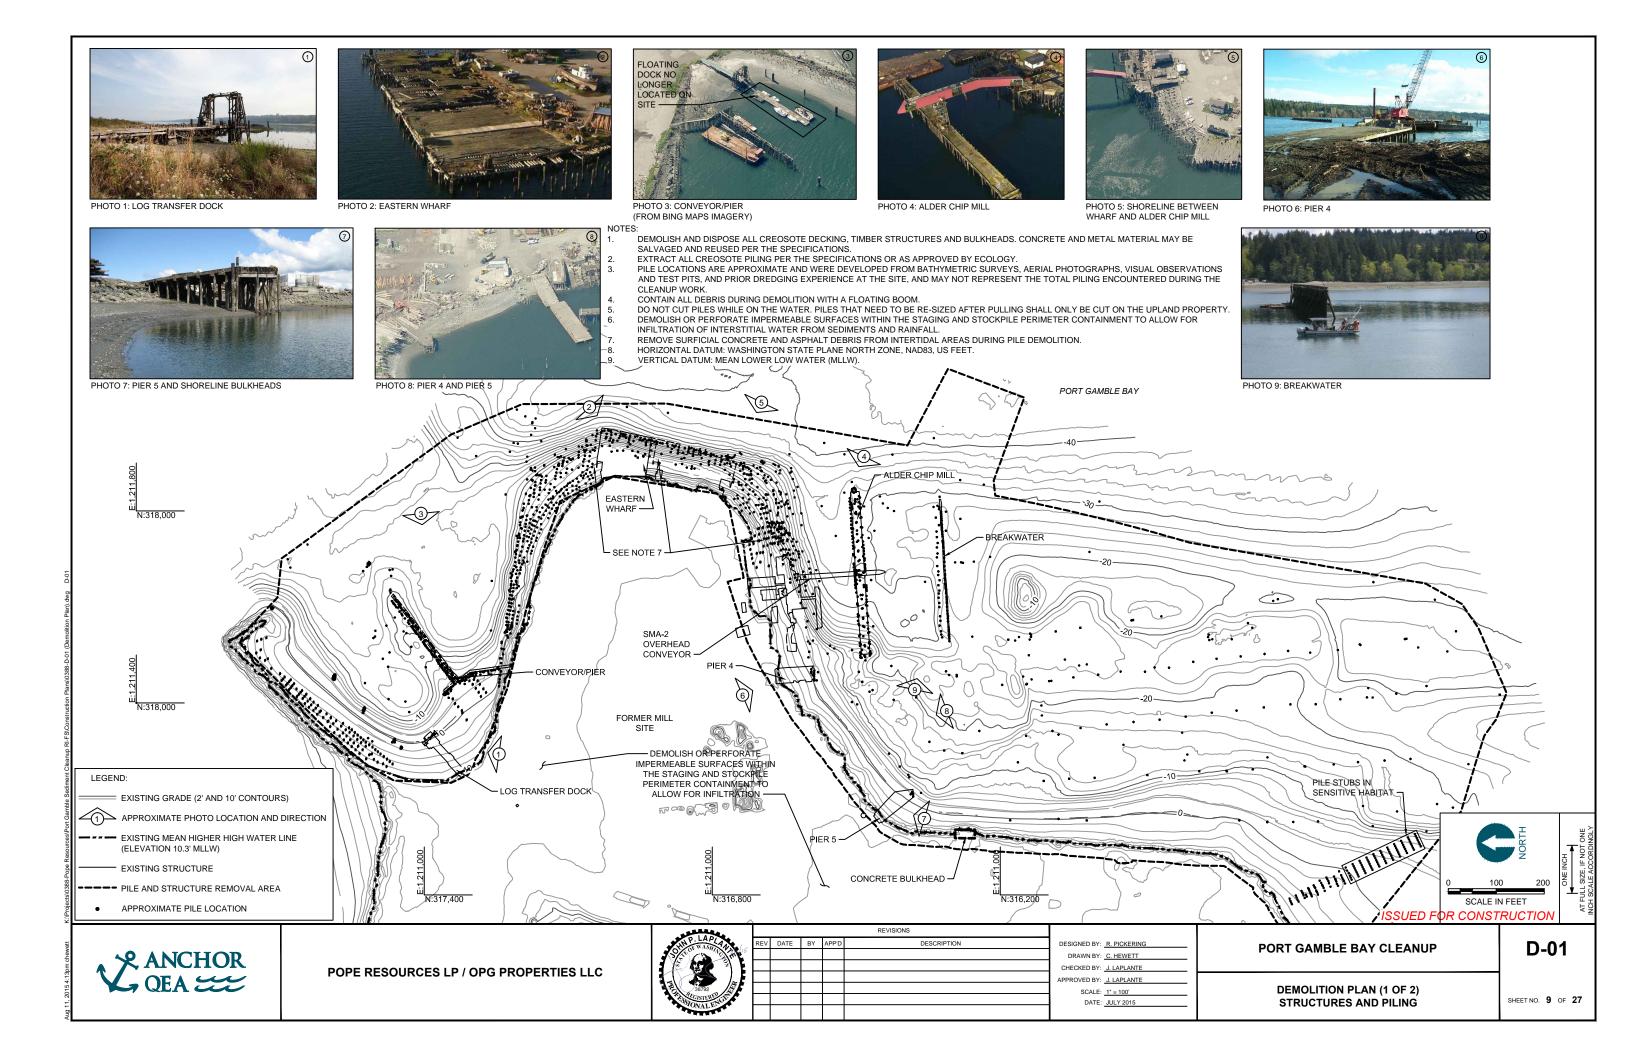


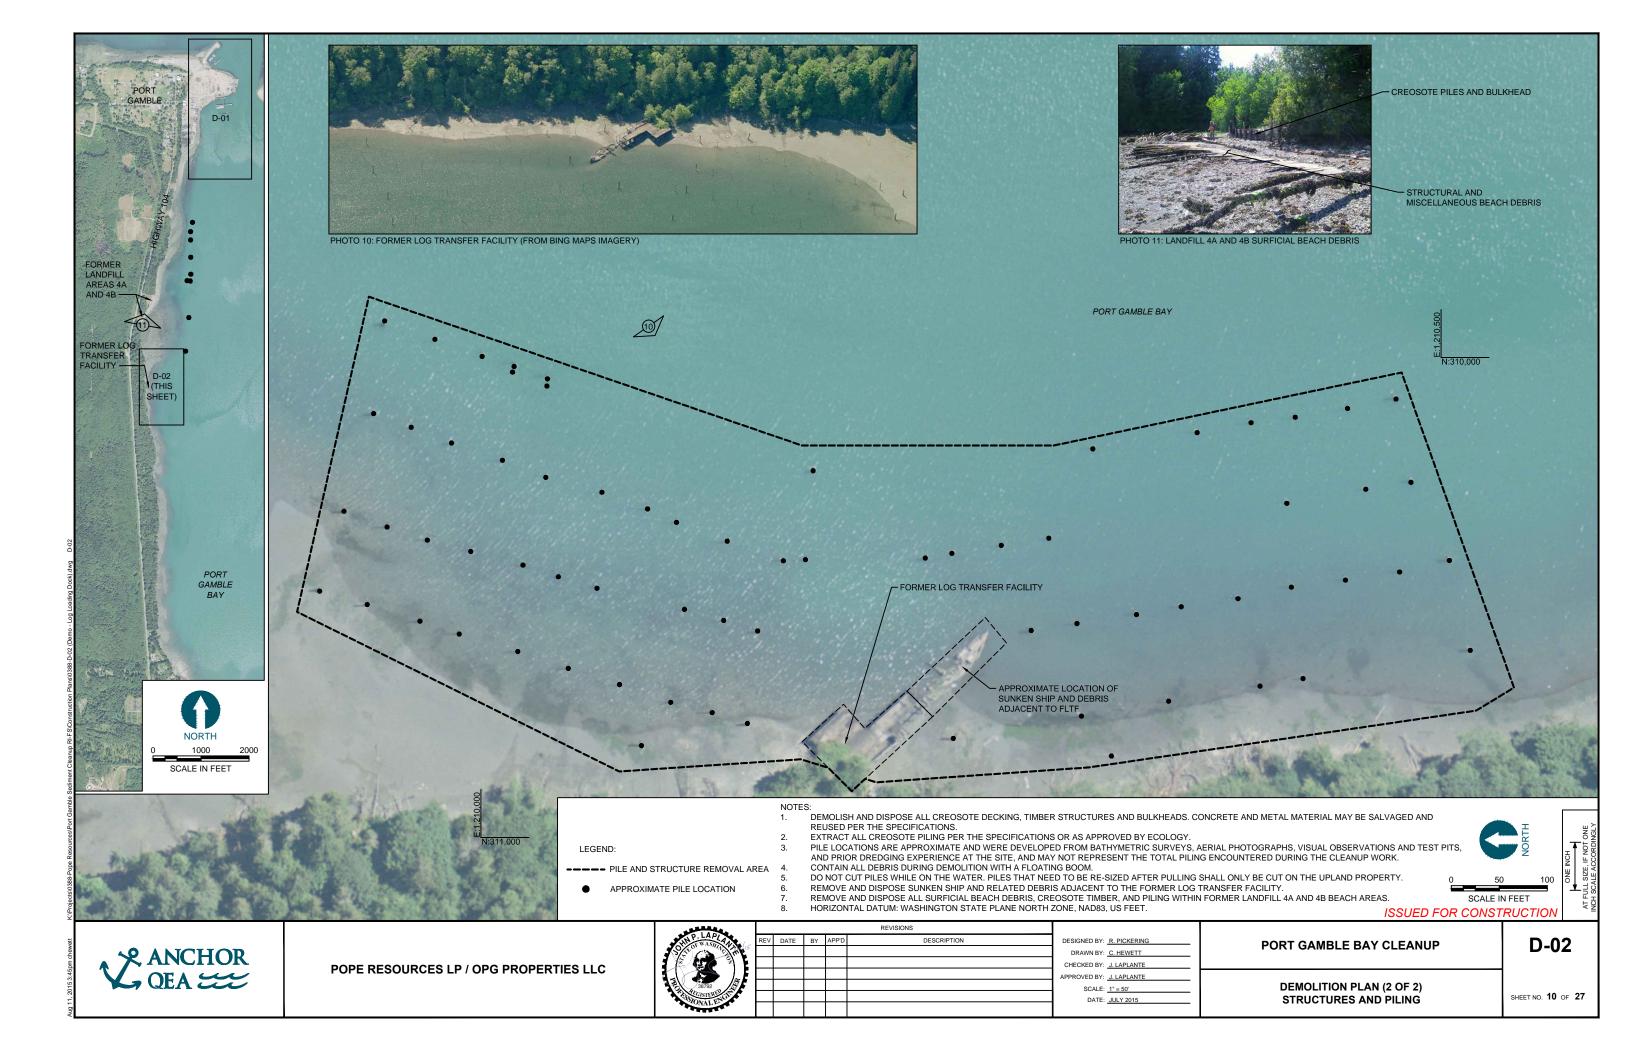


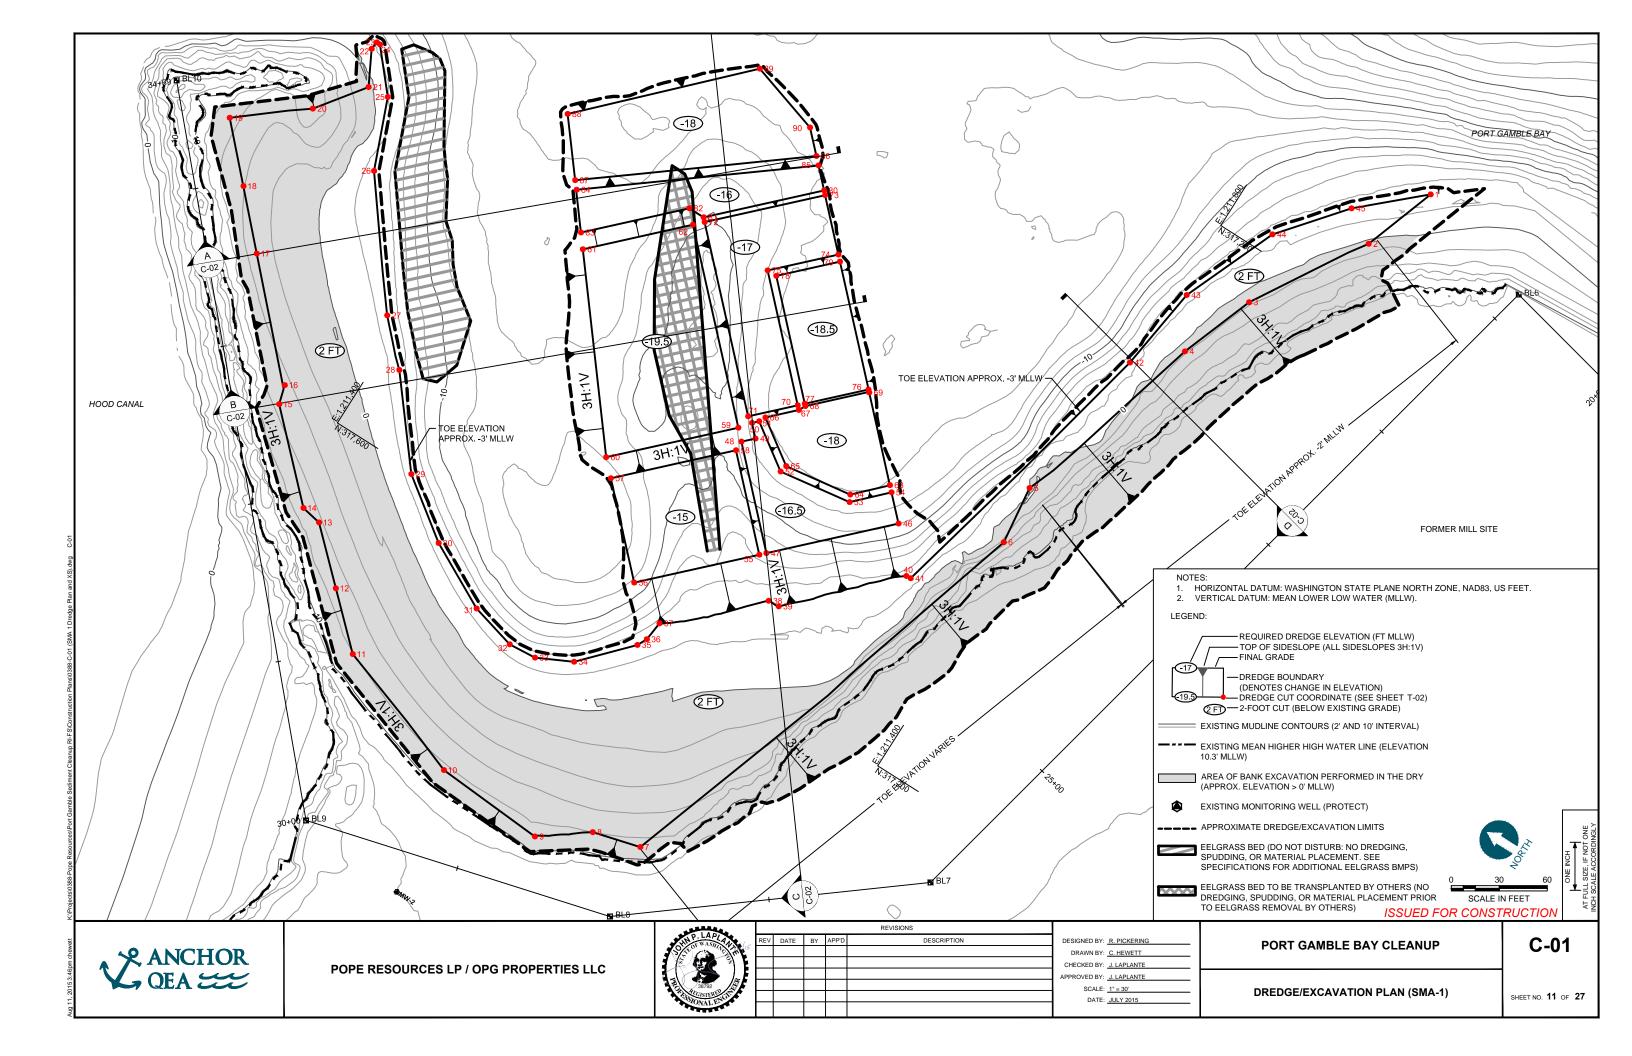


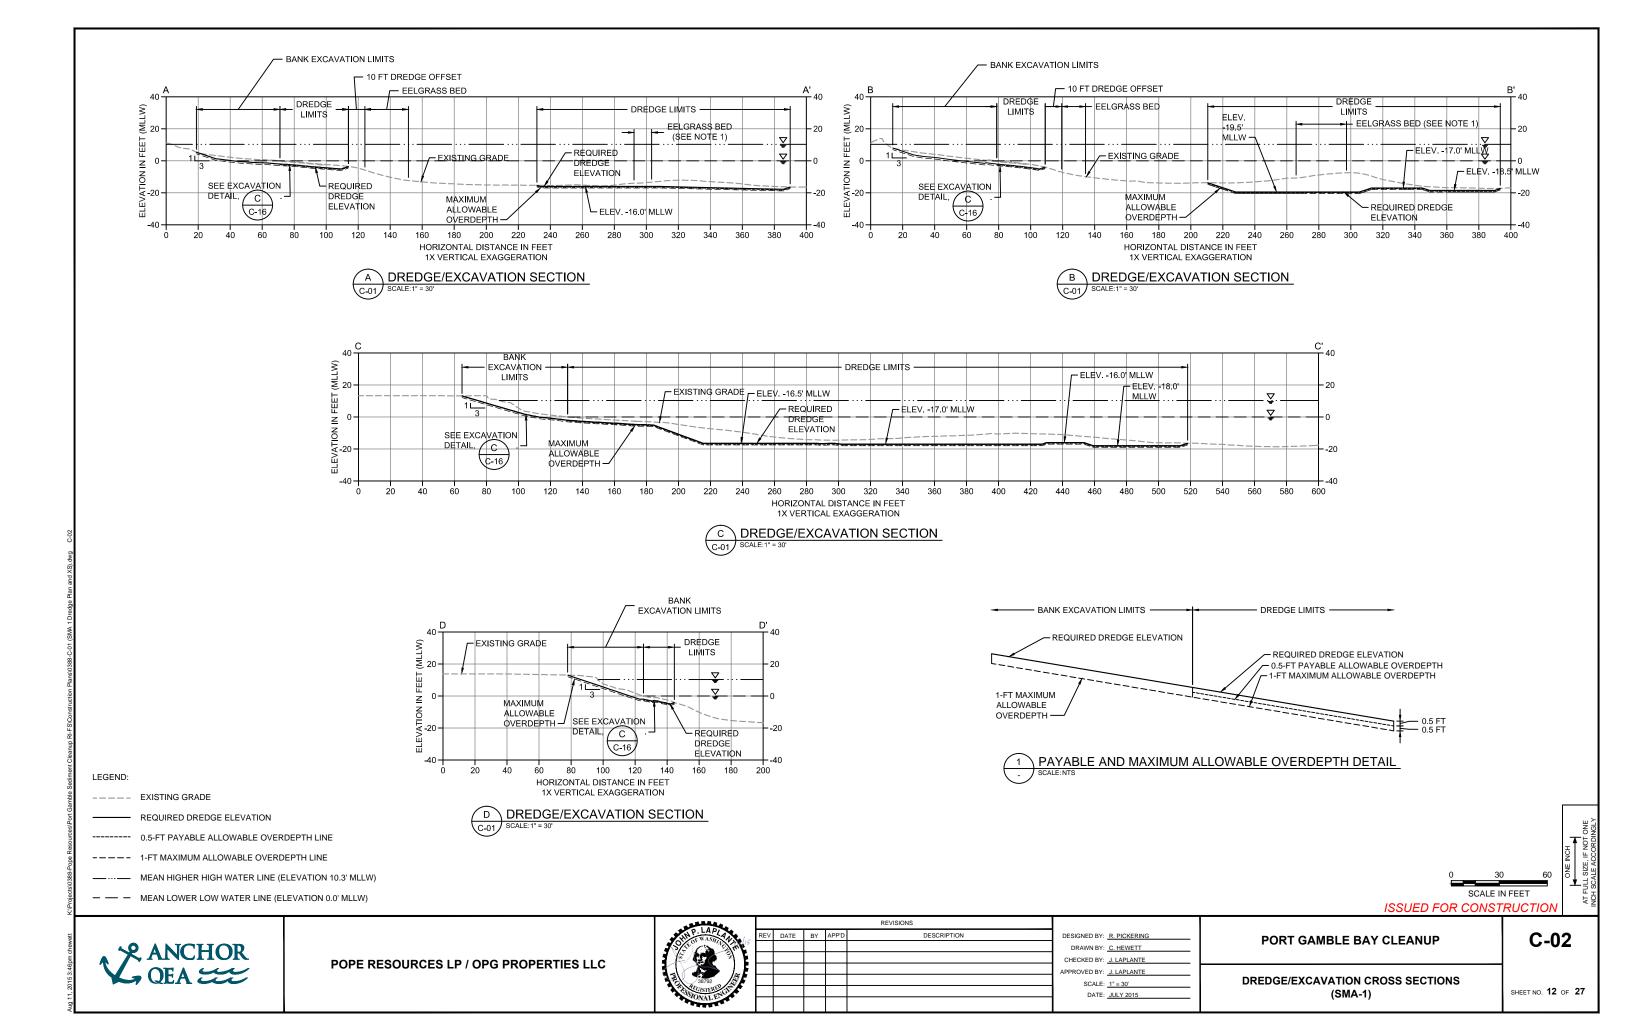


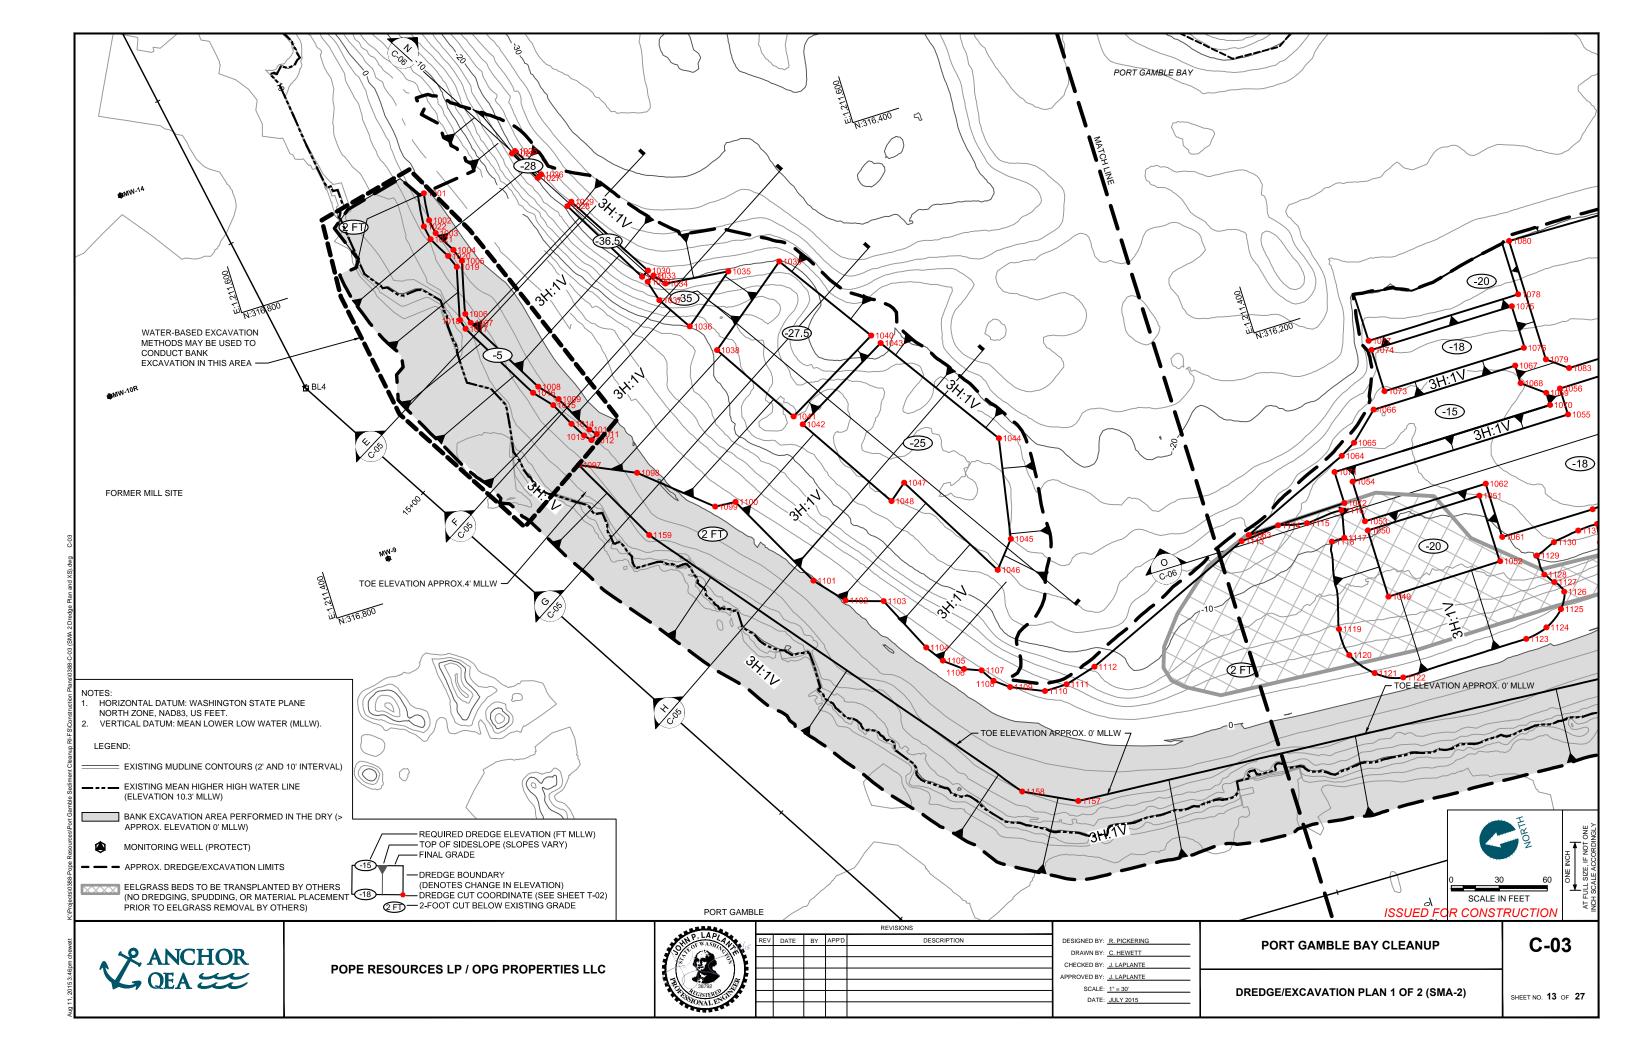


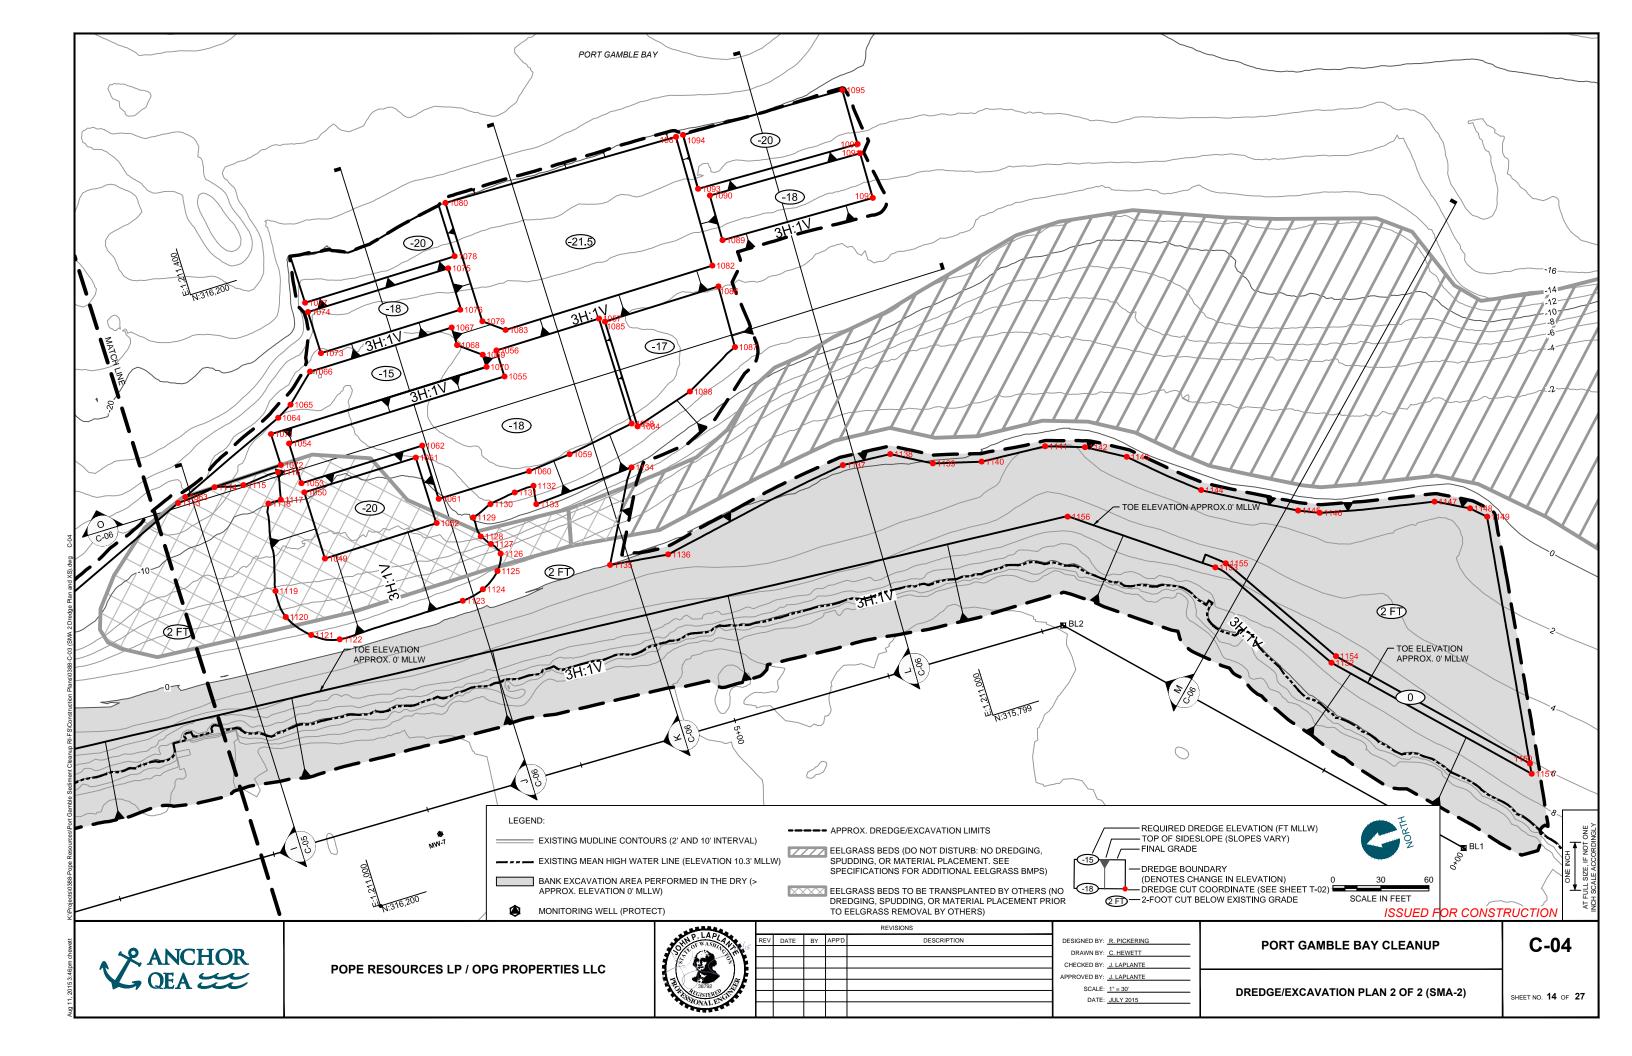

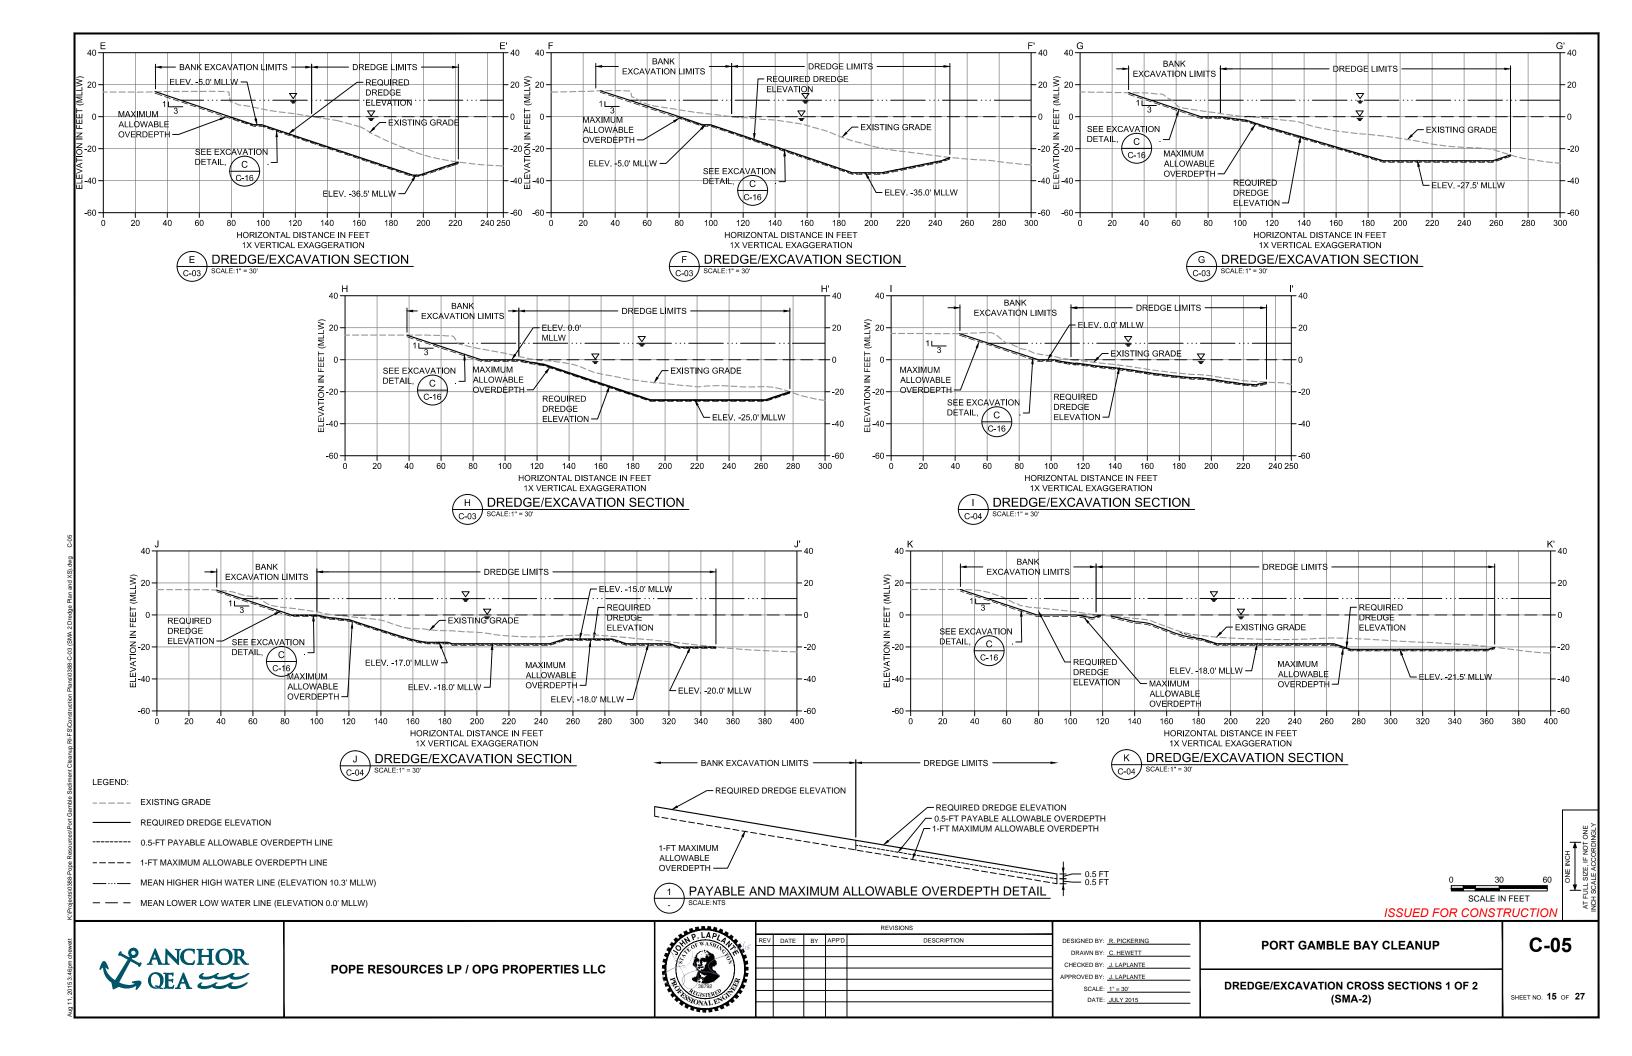

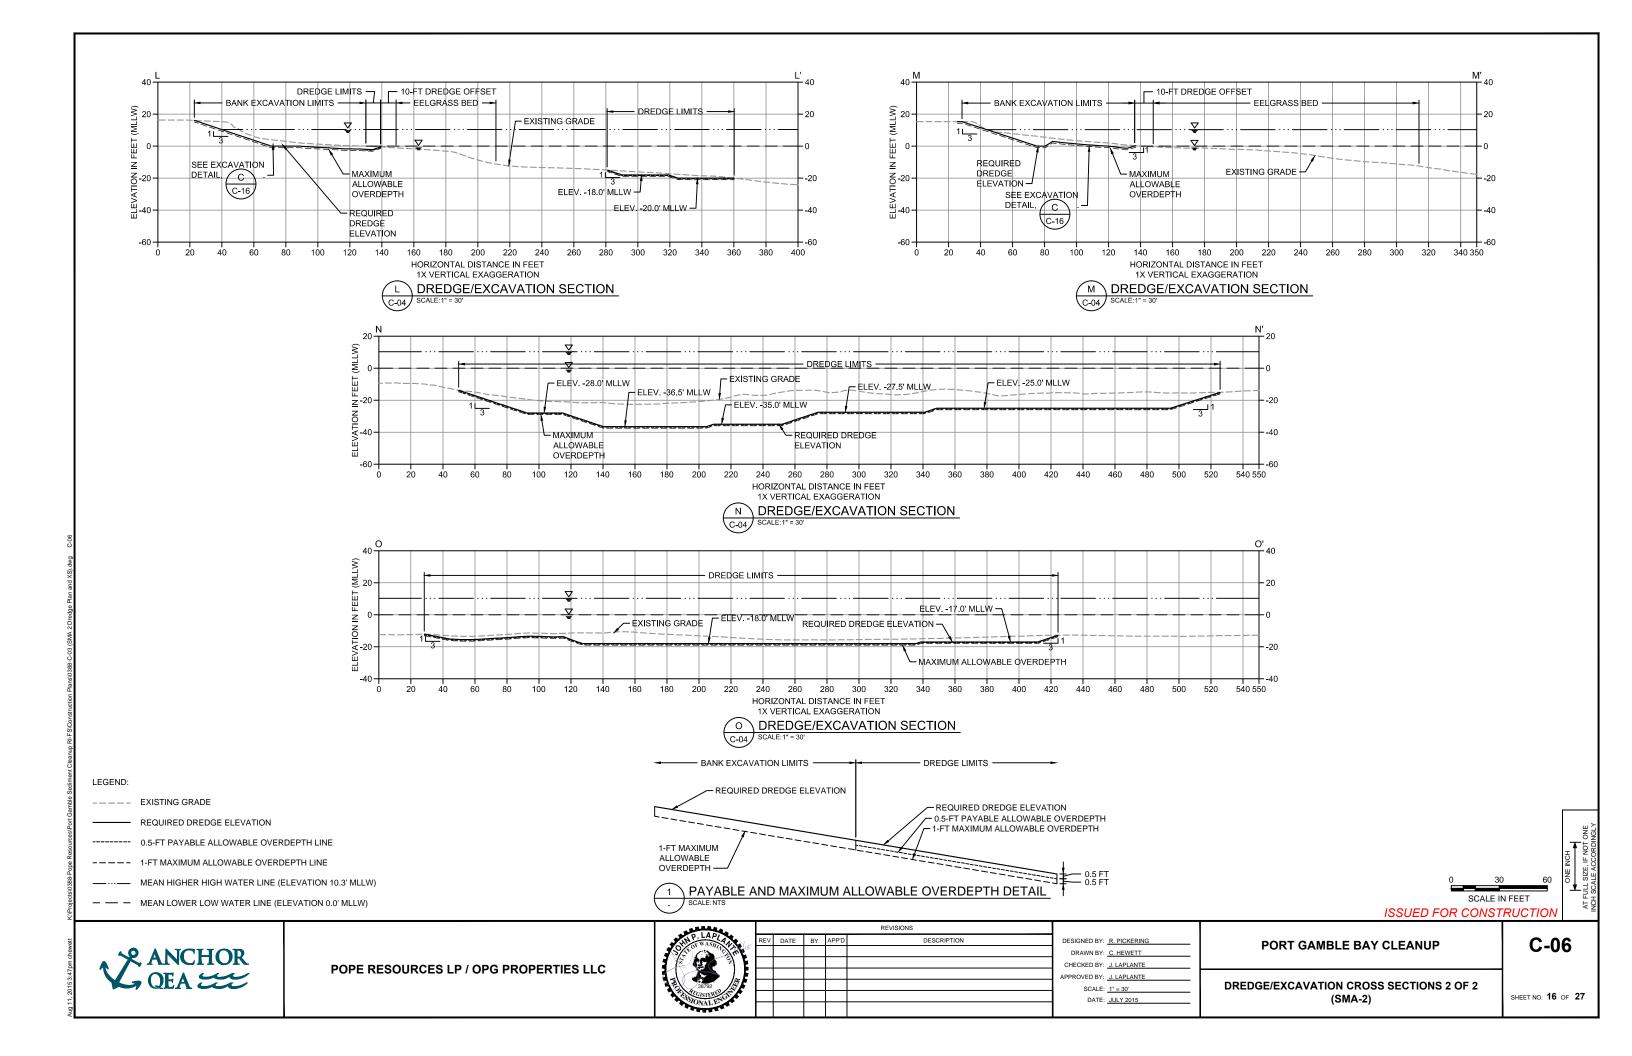

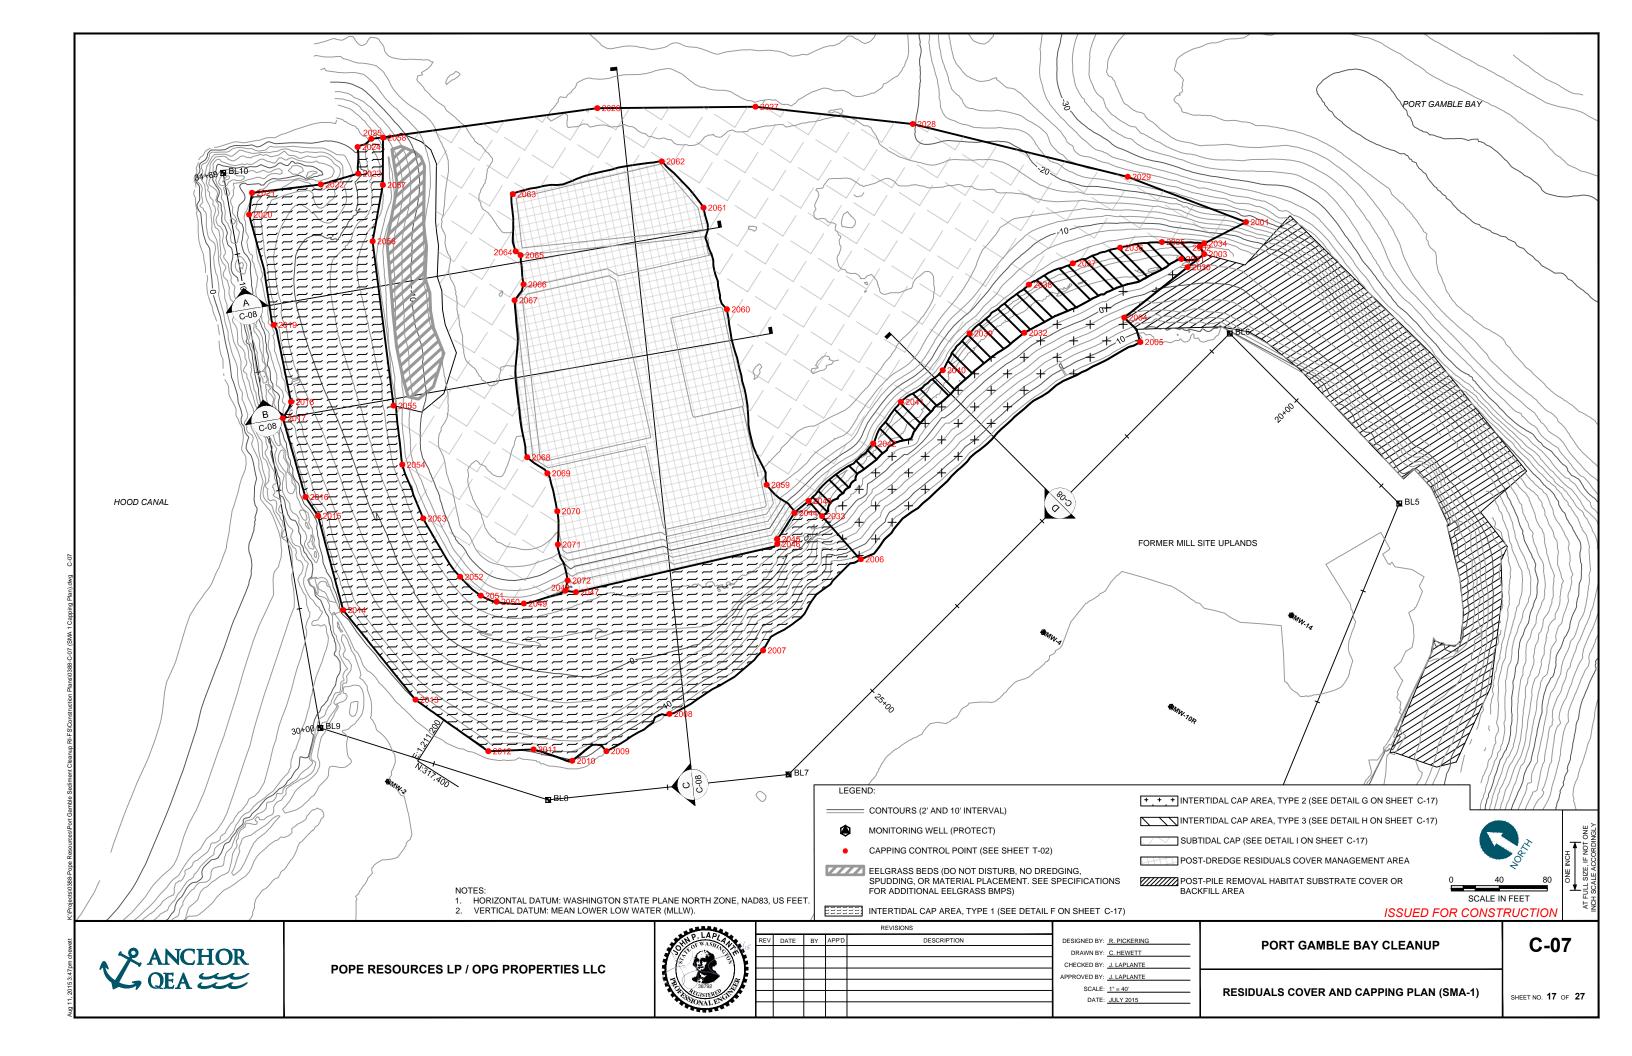

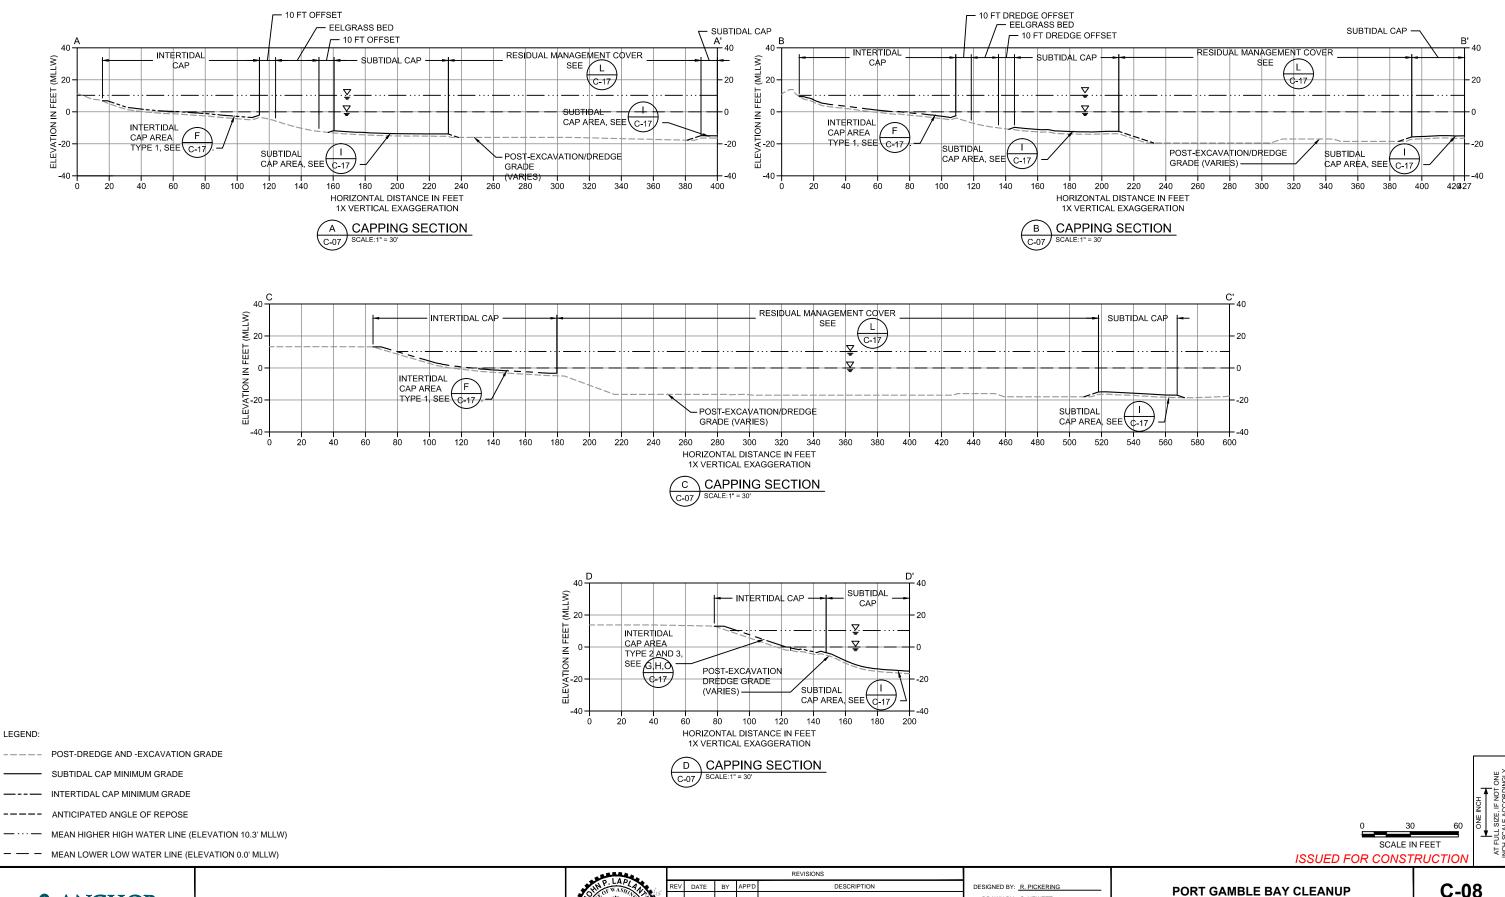

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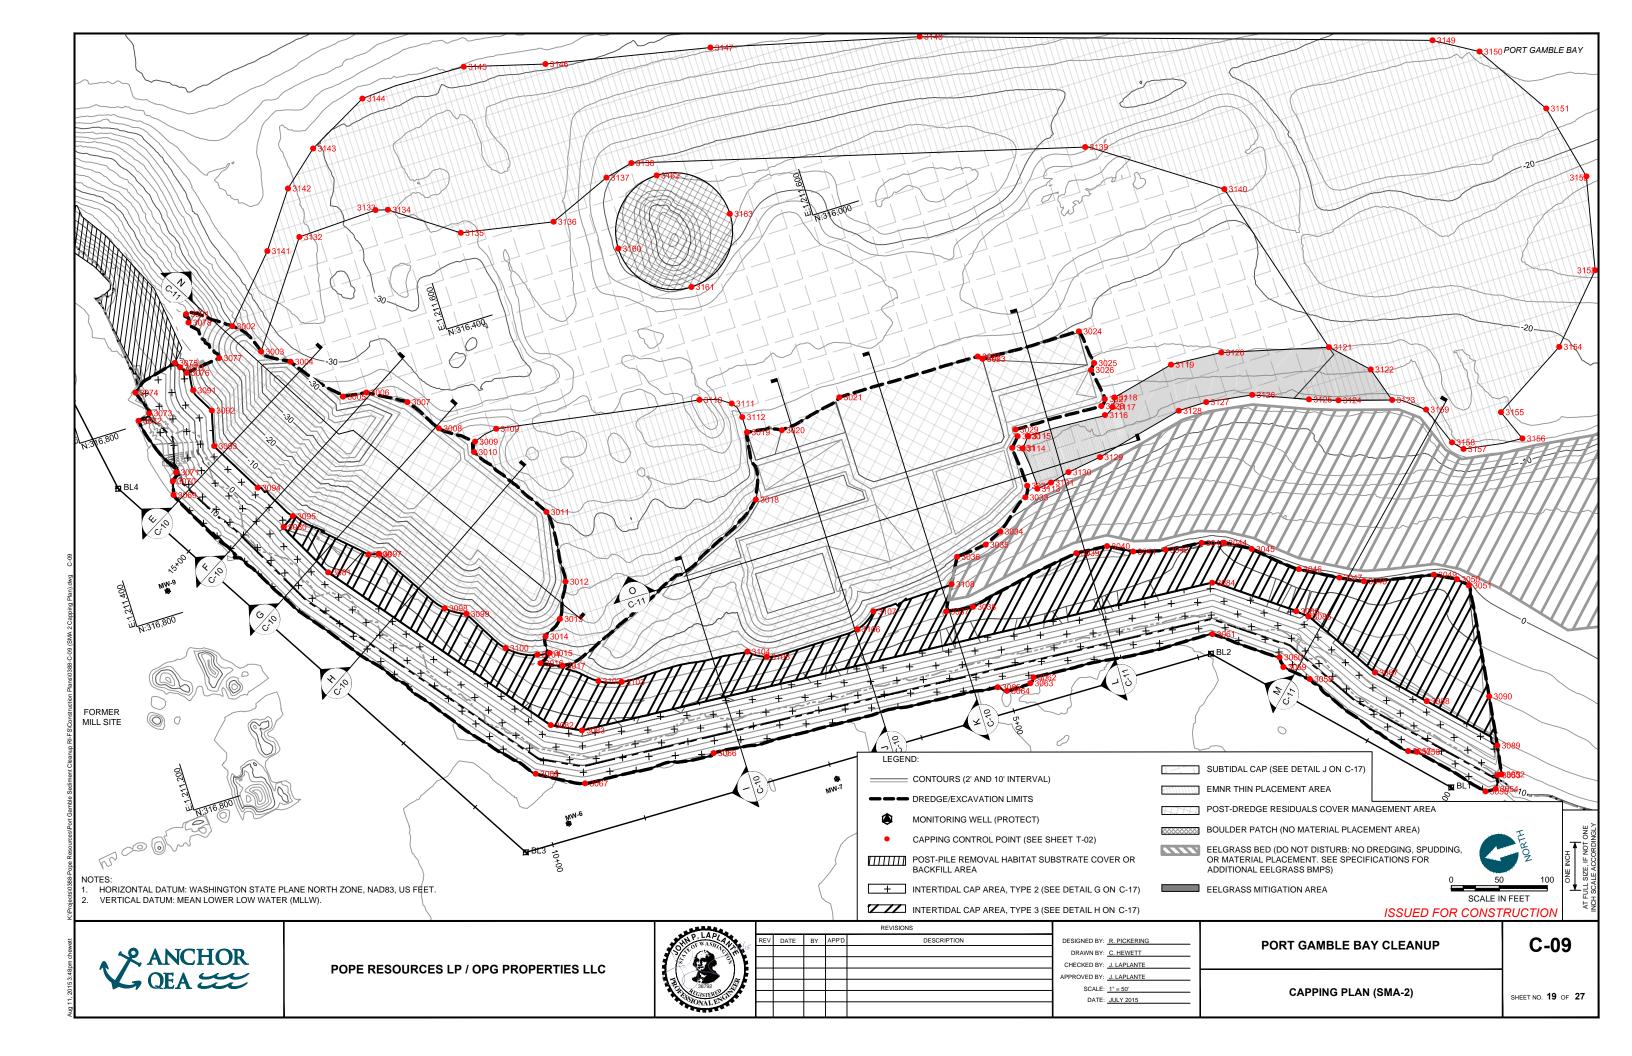
./_	REV	DATE	BY	APP'D	DESCRIPTION	DESIGNED BY:	R. PICKER
115						DRAWN BY:	C. HEWET
E						CHECKED BY:	J. LAPLAN
Æ						APPROVED BY:	J. LAPLAN
F						SCALE:	1" = 30'
						DATE:	JULY 2015


GNED BY: R. PICKERING RAWN BY: C. HEWETT CKED BY: J. LAPLANTE OVED BY: J. LAPLANTE


RESIDUALS COVER AND CAPPING CROSS SECTIONS (SMA-1)

C-08

SHEET NO. 18 OF 27



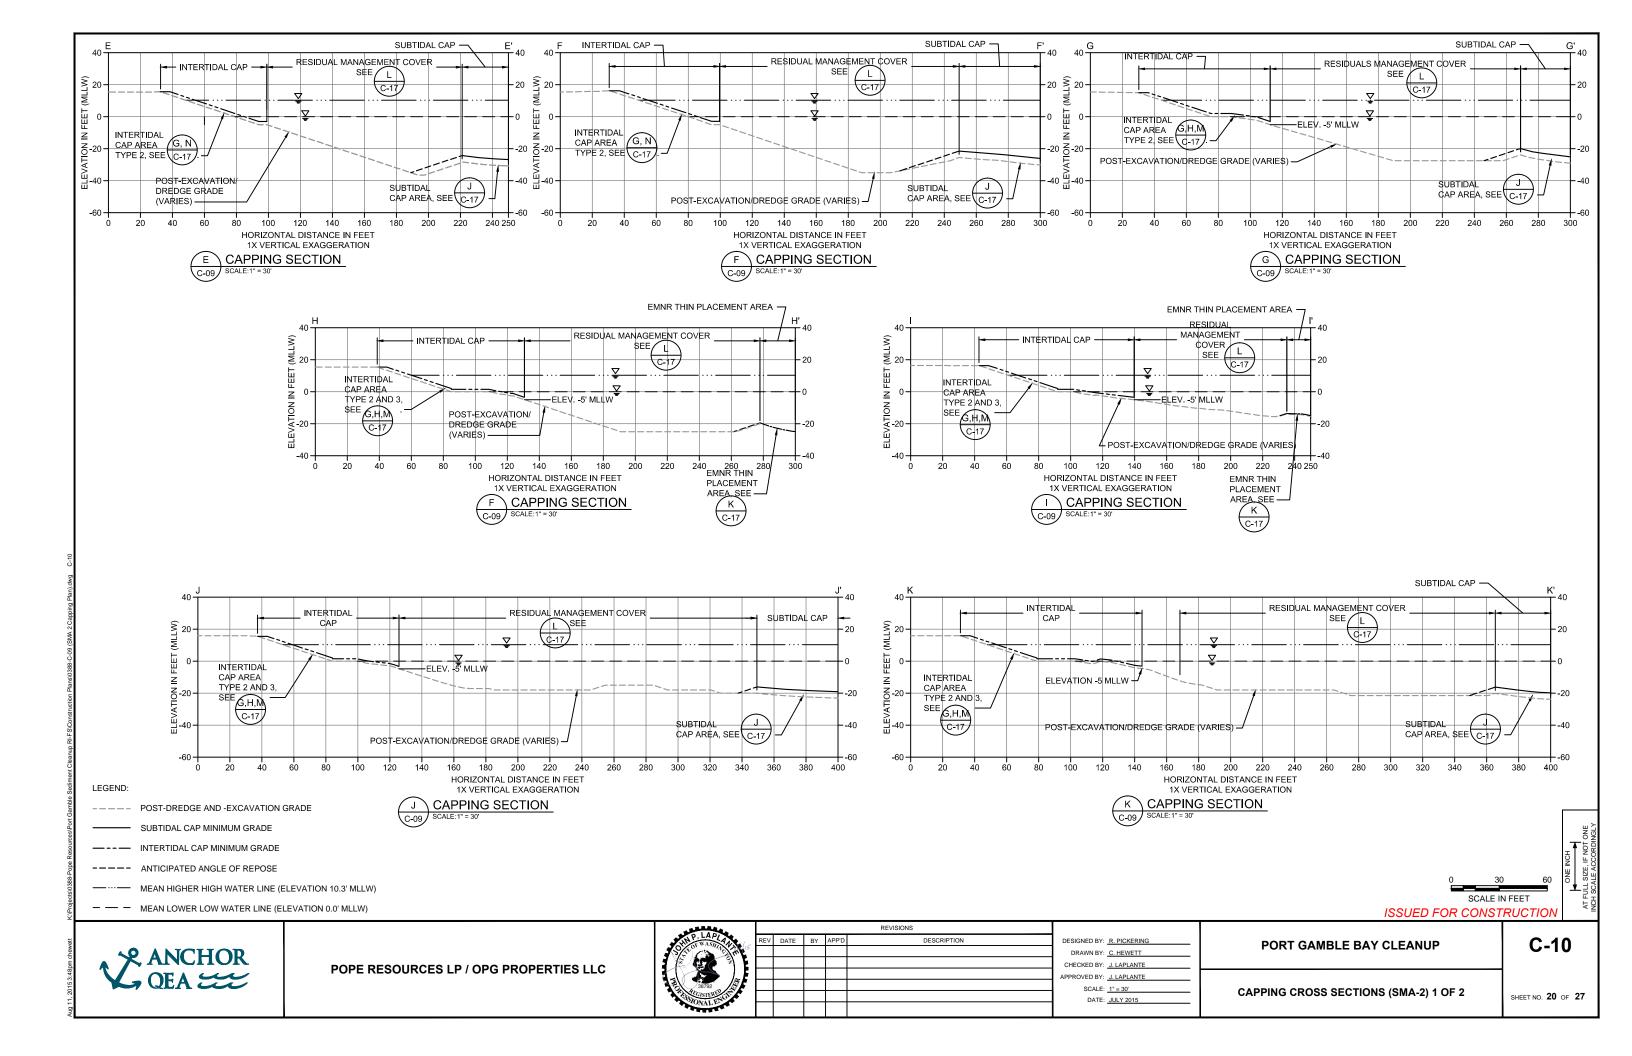

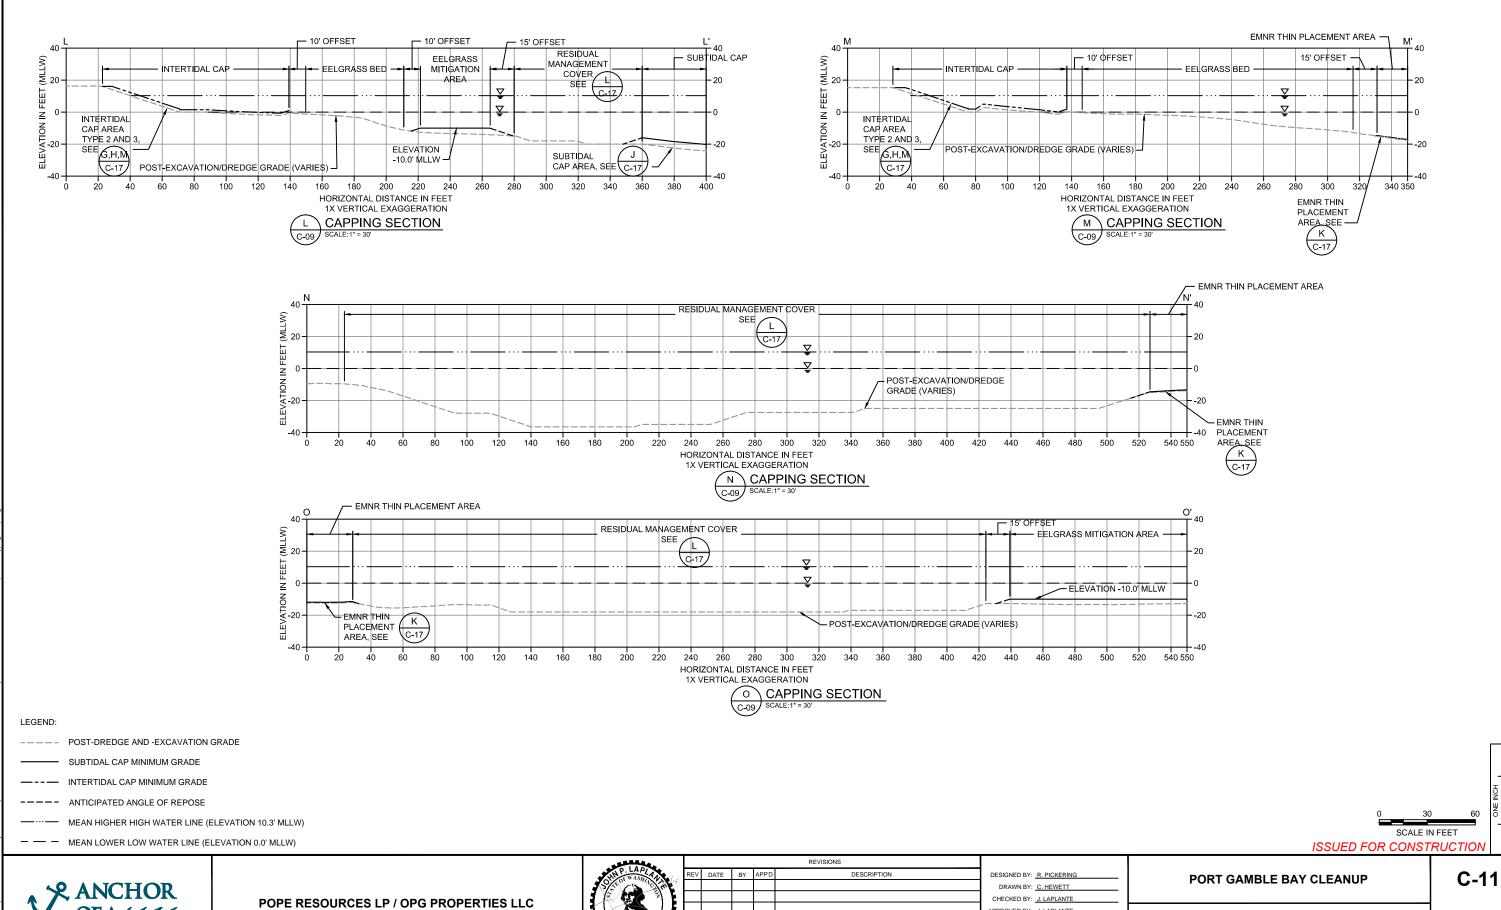

PPROVED BY: J. LAPLANTE


SCALE: 1" = 30'


DATE: JULY 2015


CAPPING CROSS SECTIONS (SMA-2) 2 OF 2

SHEET NO. 21 OF 27

Aug 11, 2015 3:48pm chewett

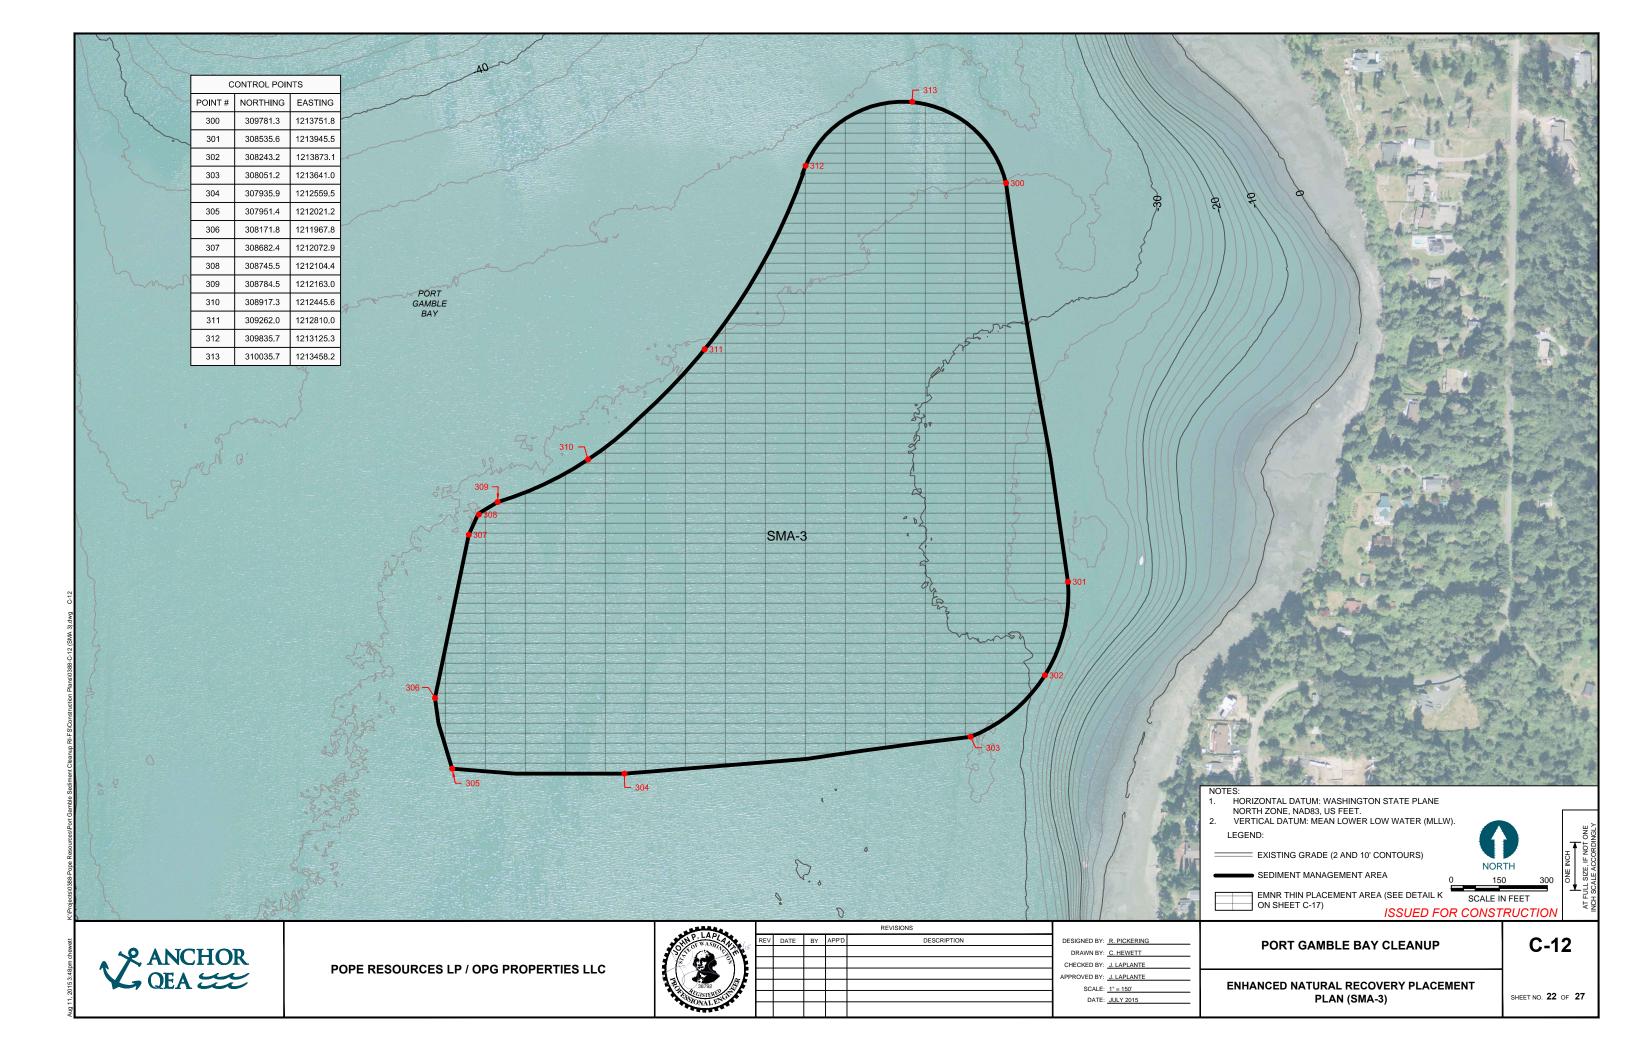

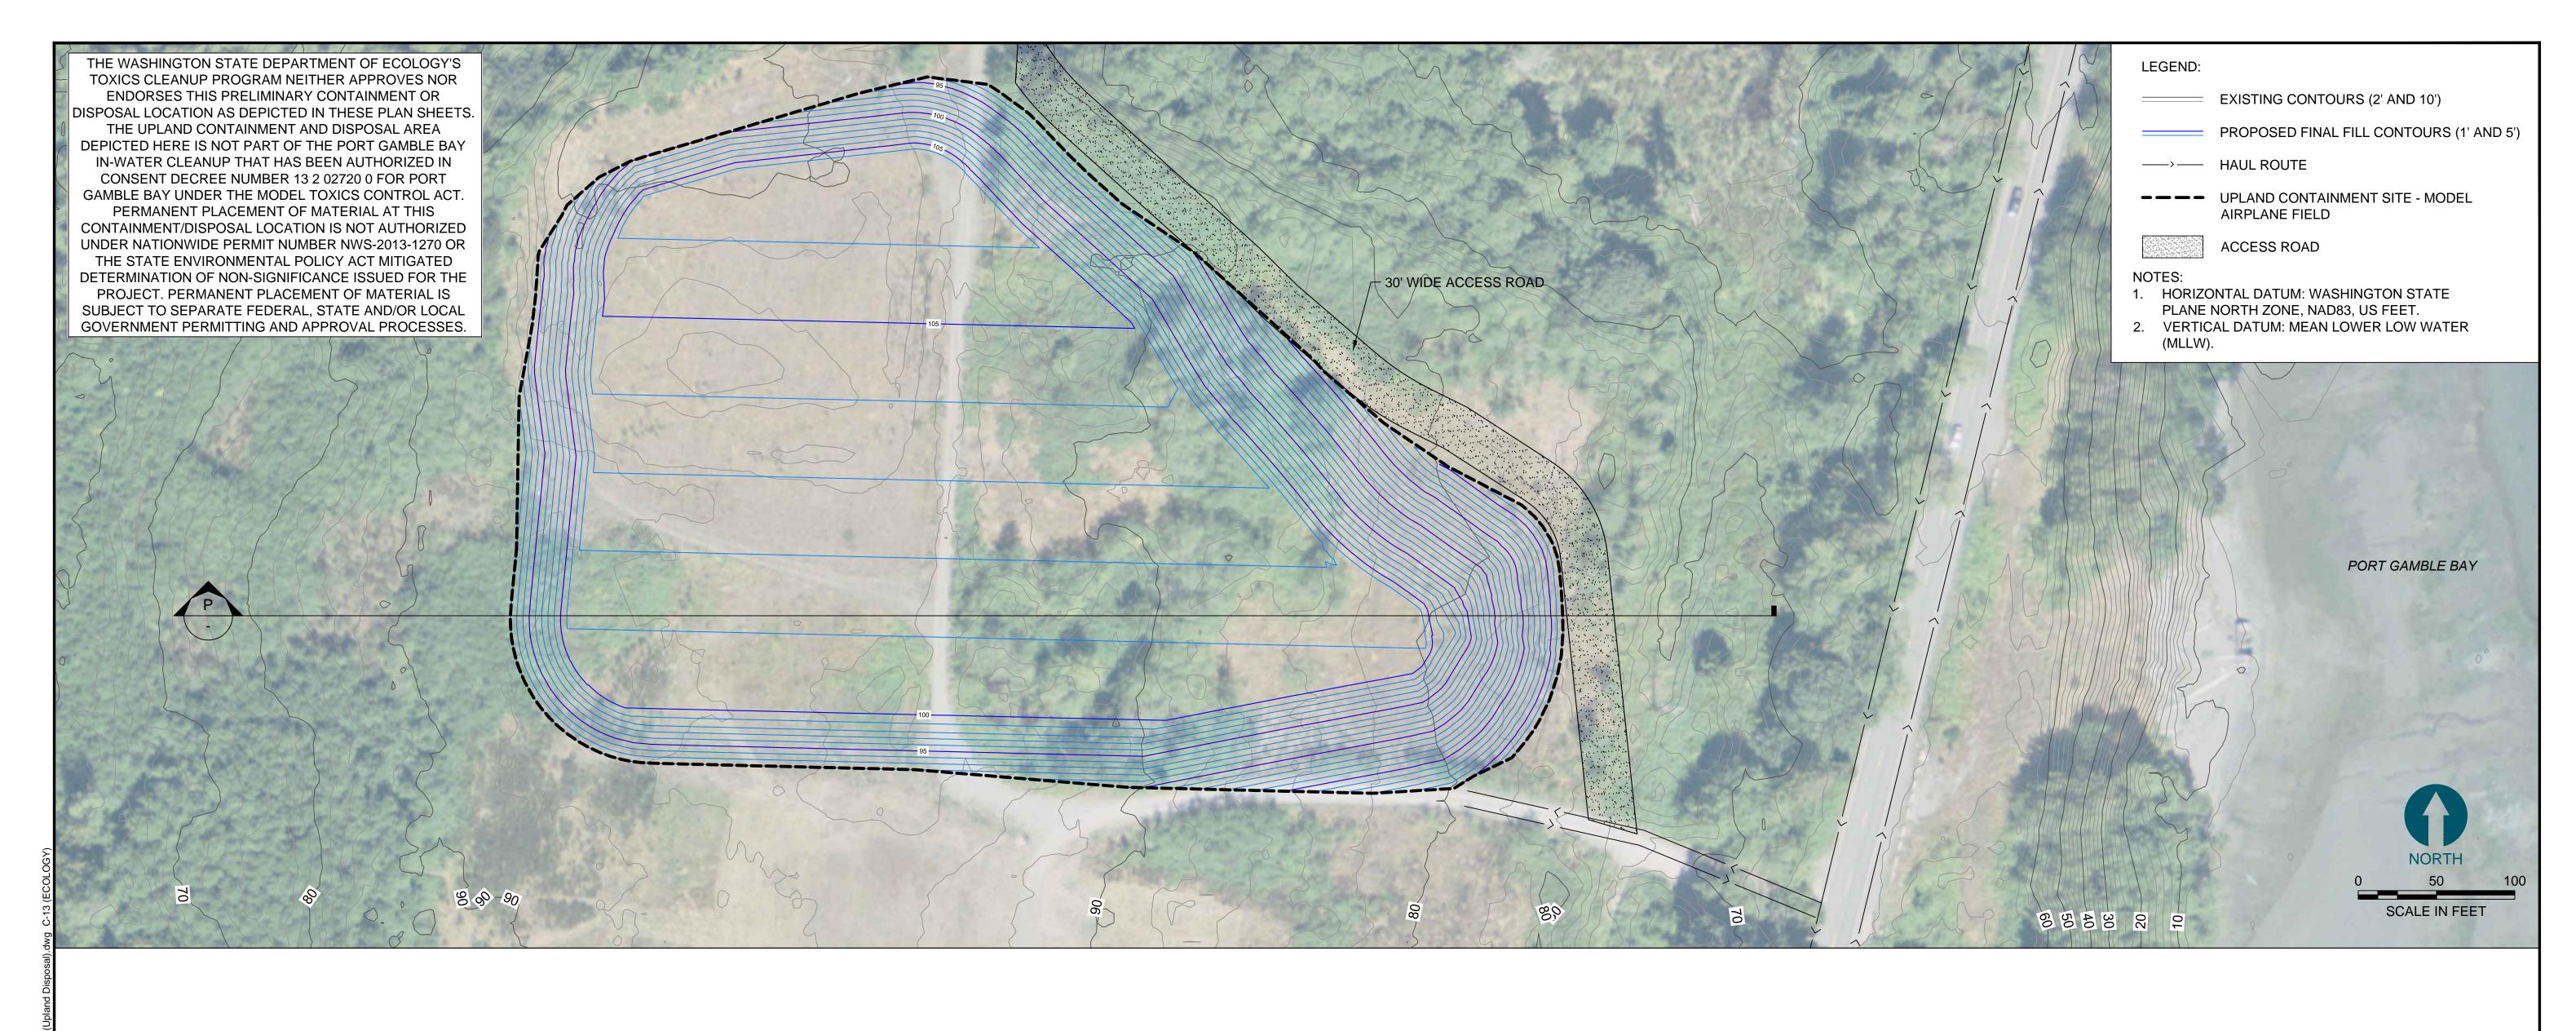

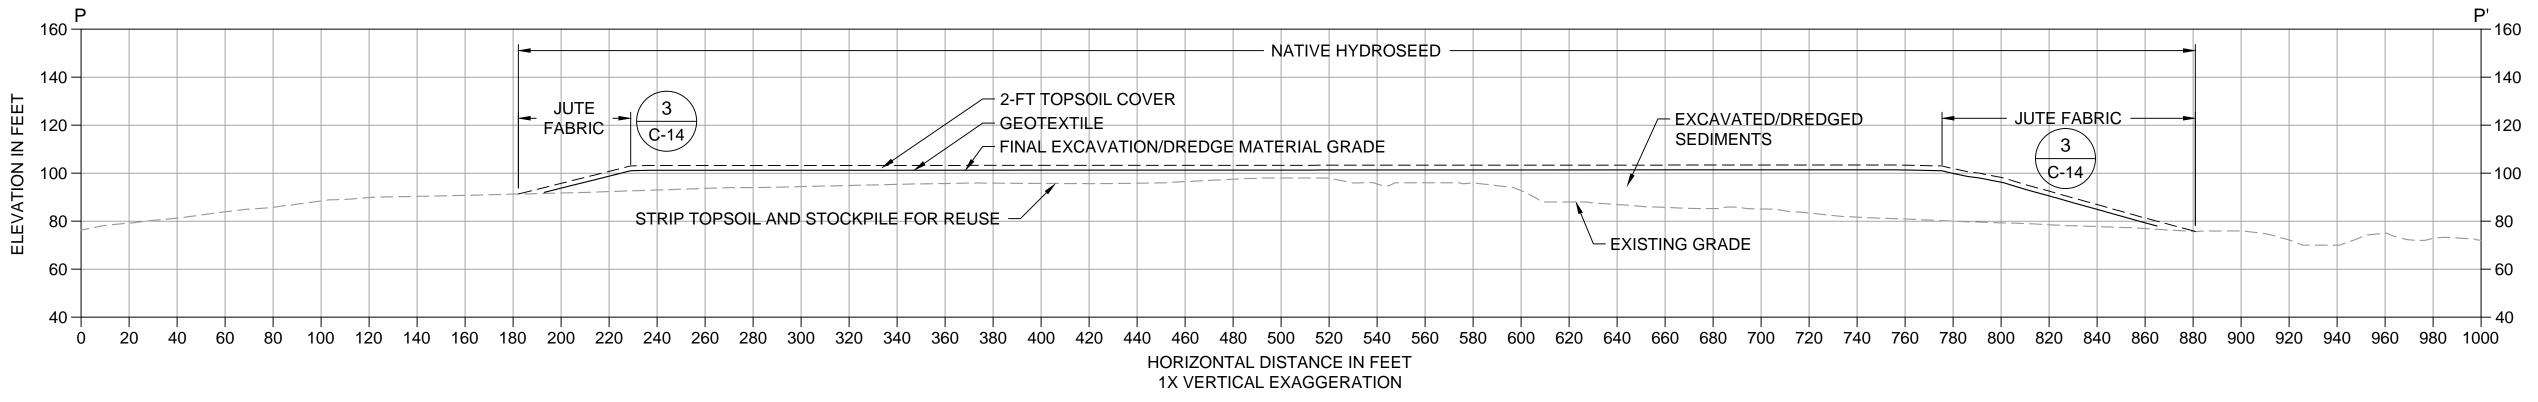

LEGEND:

---- EXISTING GRADE

——— FINAL DREDGE MATERIAL GRADE/GEOTEXTILE

----- 2-FT TOPSOIL COVER (FINAL GRADE)


UPLAND CONTAINMENT SITE SECTION SCALE:1" = 30'

SCALE IN FEET

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POPE RESOURCES LP / OPG PROPERTIES LLC



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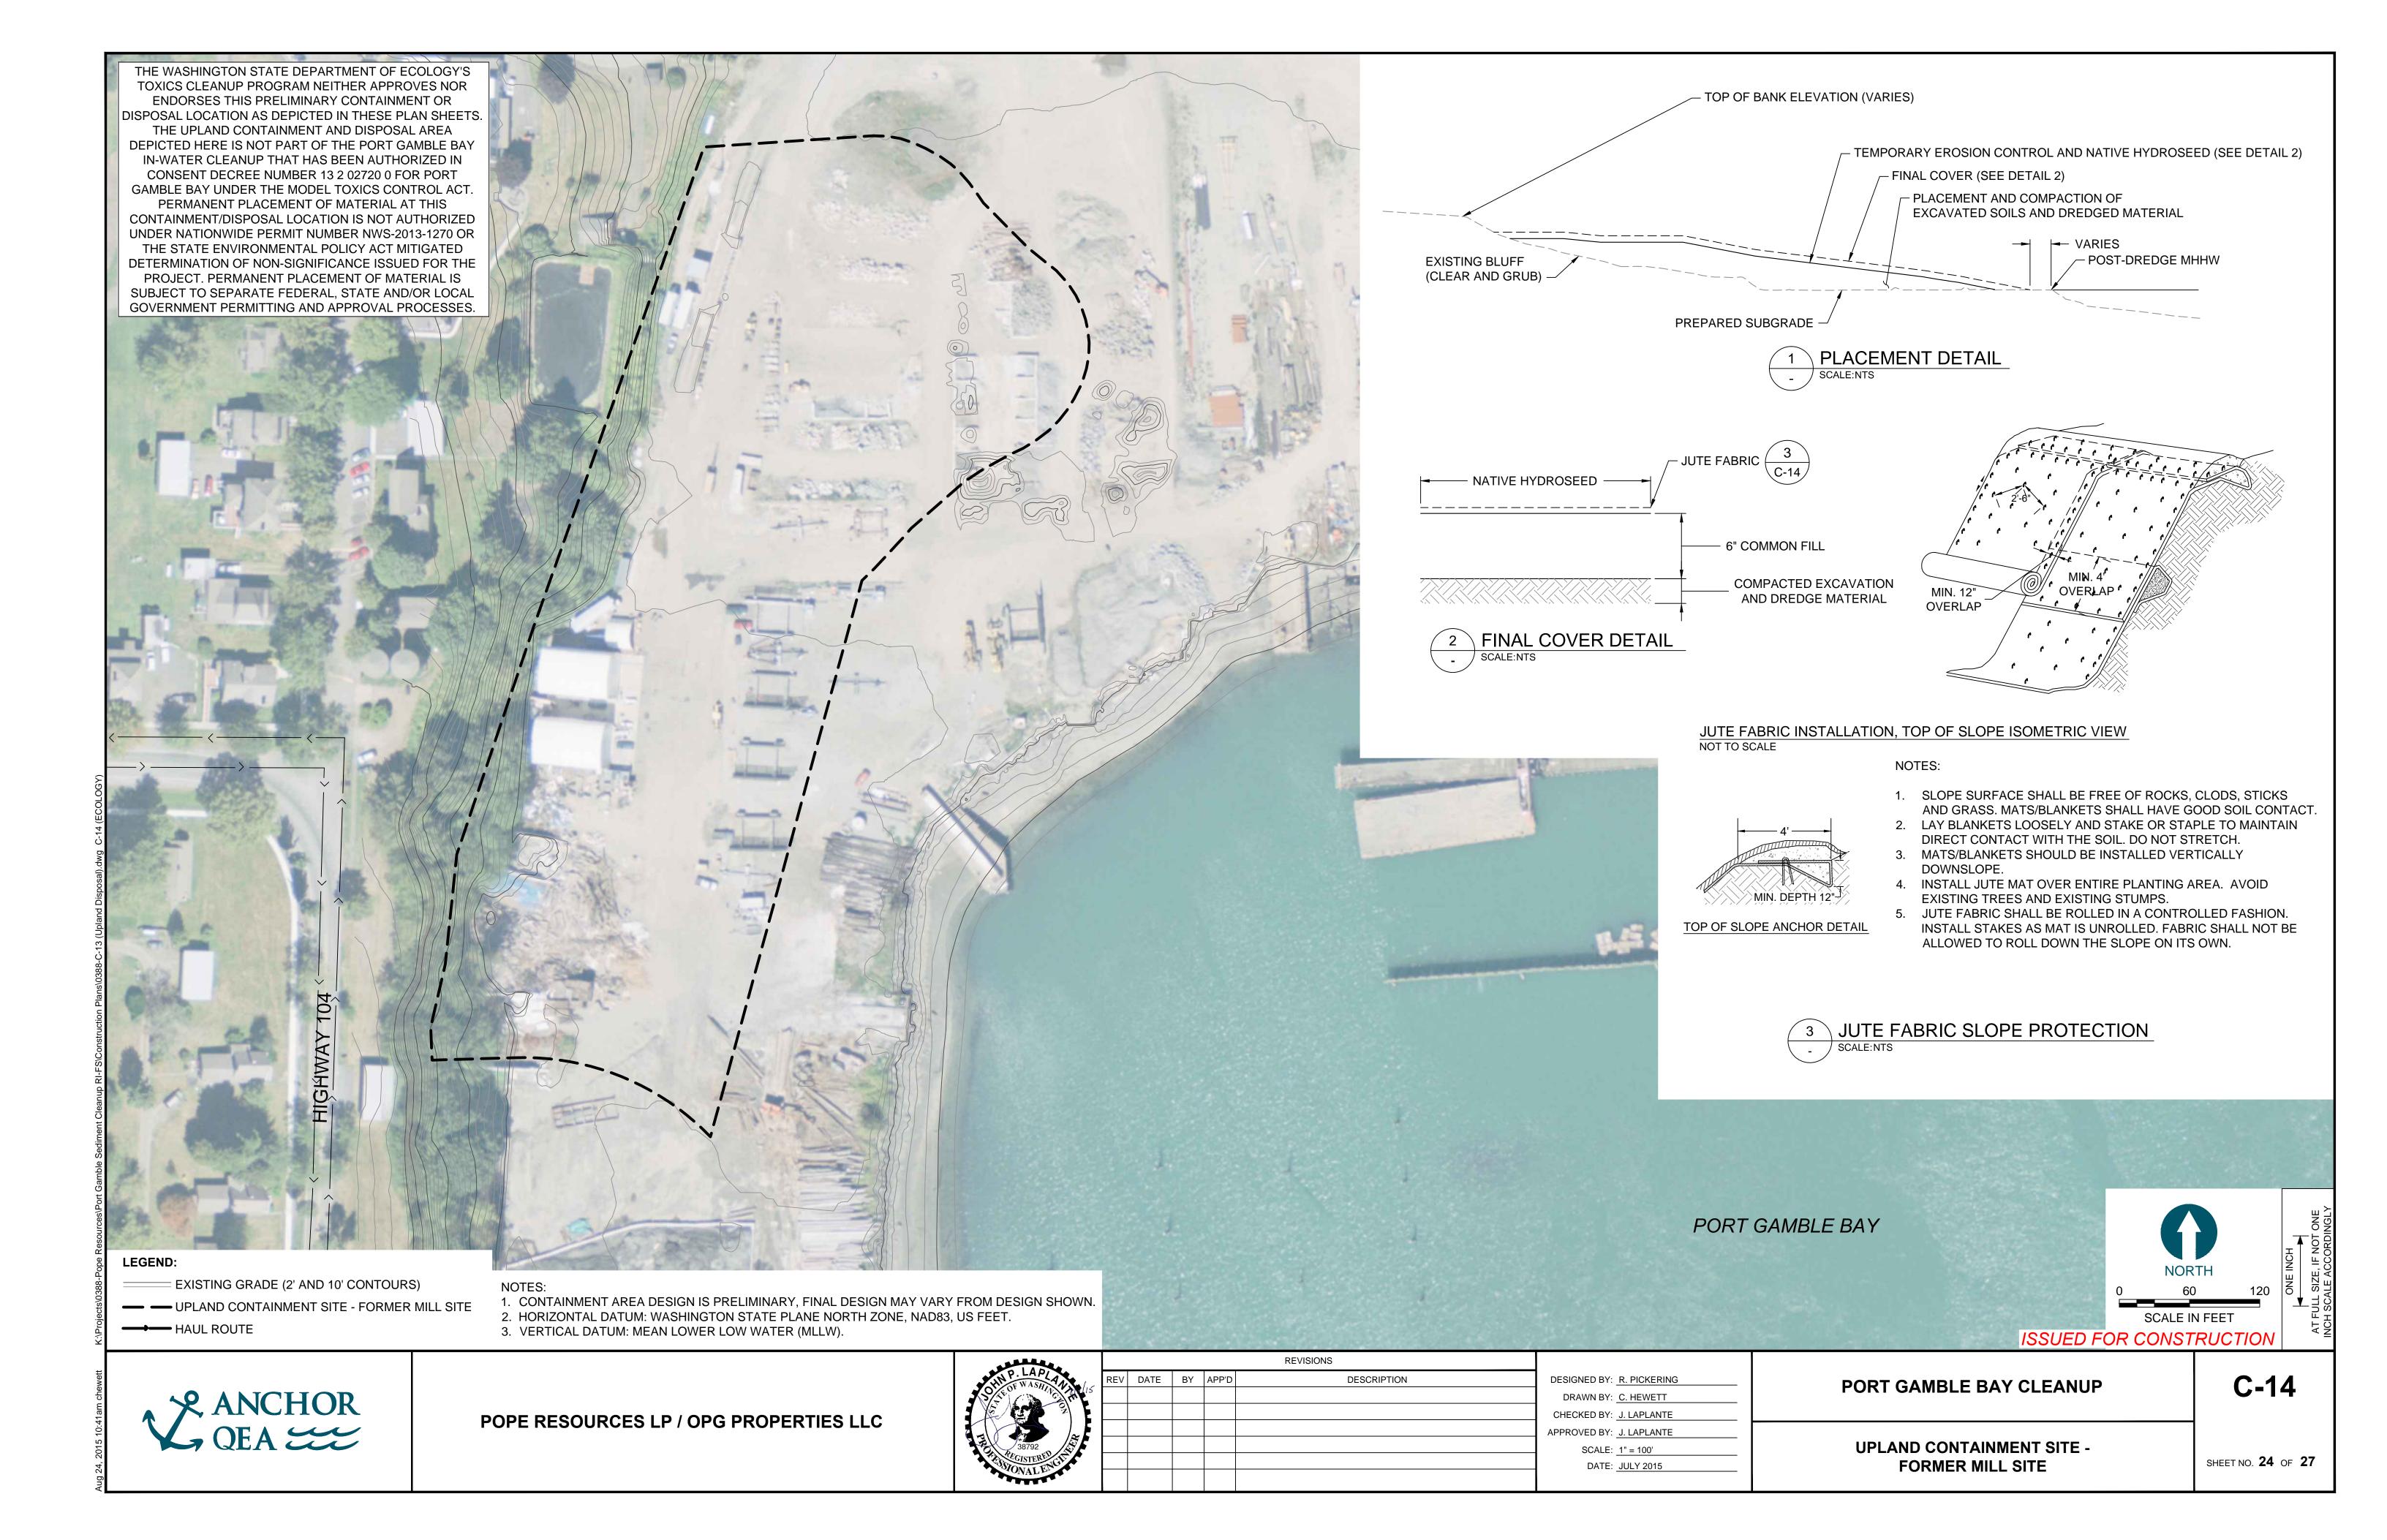
GNED BY: R. PICKERING RAWN BY: <u>C. HEWETT</u> CKED BY: J. LAPLANTE OVED BY: J. LAPLANTE SCALE: AS NOTED DATE: JULY 2015

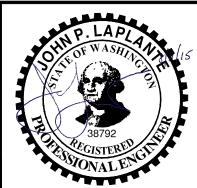
PORT GAMBLE BAY CLEANUP

UPLAND CONTAINMENT SITE -MODEL AIRPLANE FIELD

C-13

SHEET NO. **23** OF **27**



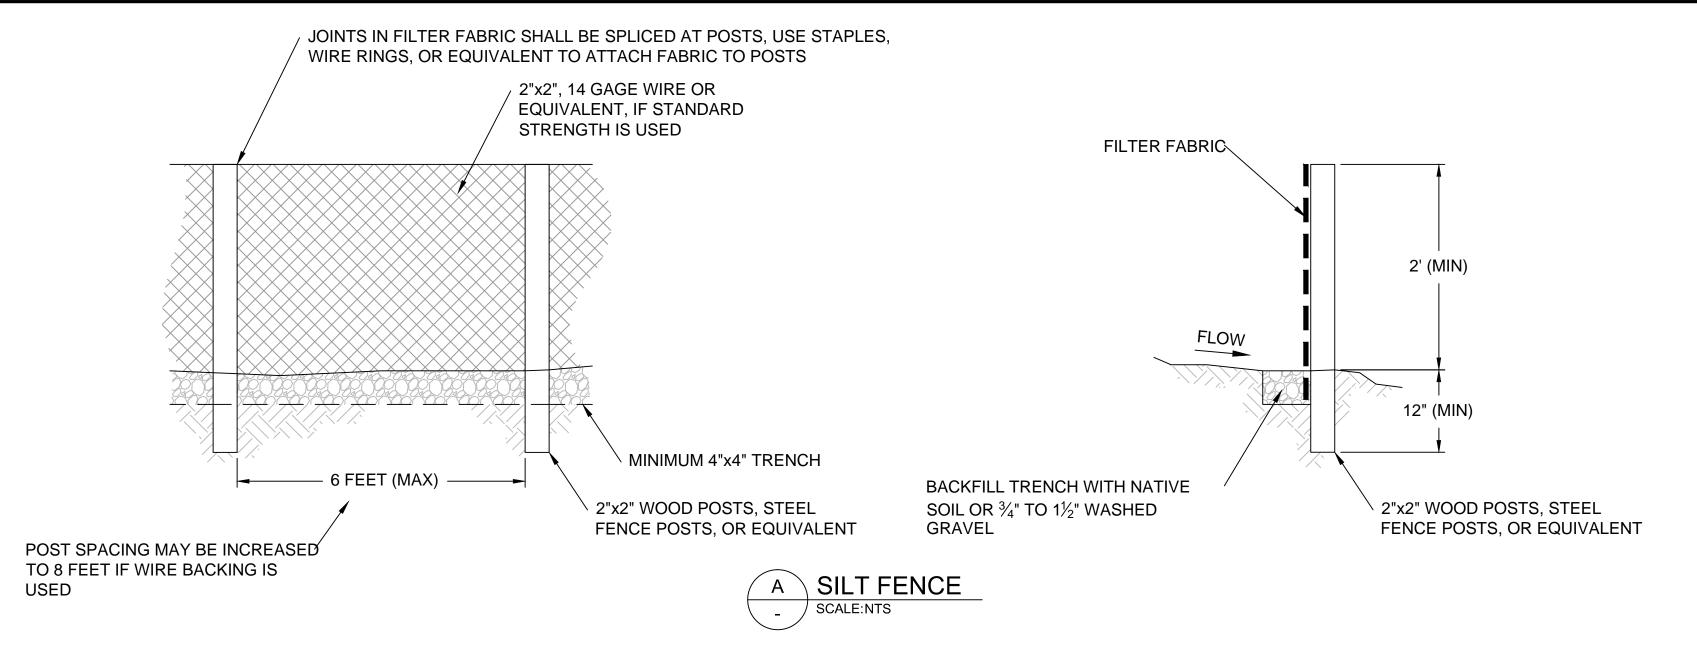


NOTES:

OVERFLOW BYPASS SEDIMENT AND DEBRIS _ FILTERED WATER

GRATE -

- - **CROSS SECTION** NOT TO SCALE

- 1. PERFORM MAINTENANCE IN ACCORDANCE WITH SPECIFICATIONS.
- 2. SIZE THE BELOW GRATE INLET DEVICE (BGID) FOR THE STORM WATER STRUCTURE IT WILL SERVICE.
- 3. THE BGID SHALL HAVE A BUILT-IN HIGH-FLOW RELIEF SYSTEM (OVERFLOW BYPASS).
- 4. THE RETRIEVAL SYSTEM MUST ALLOW REMOVAL OF THE BGID WITHOUT SPILLING THE COLLECTED MATERIAL.

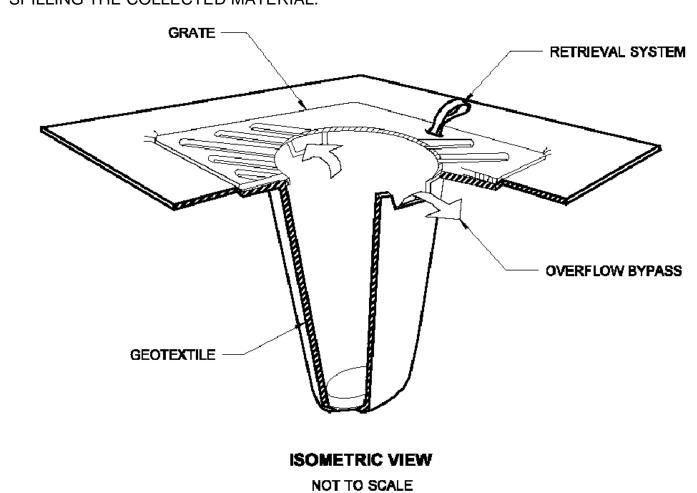



EROSION CONTROL NOTES:

- 1. THE CONTRACTOR SHALL BE RESPONSIBLE FOR FURNISHING, INSTALLING, AND MAINTAINING ALL MEASURES NECESSARY TO MEET CONSTRUCTION BEST MANAGEMENT PRACTICES (BMPS) IN ACCORDANCE WITH WASHINGTON STATE DEPARTMENT OF ECOLOGY STORMWATER MANAGEMENT MANUAL FOR WESTERN WASHINGTON (2012), WSDOT HIGHWAY RUNOFF MANUAL (2014), AND ALL OTHER STATE AND LOCAL REQUIREMENTS.
- 2. TEMPORARY EROSION AND SEDIMENT CONTROL (TESC) FEATURES SHALL BE INSTALLED TO PREVENT RUNOFF FROM THE DEWATERED SEDIMENT FROM ENTERING ADJACENT SURFACE WATER BODY. THE NEED FOR THESE FEATURES, AND THEIR LOCATION, SHALL BE DETERMINED DURING CONSTRUCTION BASED ON THE ACTUAL LOCATION OF THE OFFLOADING AND TEMPORARY STORAGE ACTIVITIES.
- 3. FILTER FABRIC SILT FENCES, WHERE USED, SHALL BE INSTALLED ALONG A CONTOUR OF CONSTANT ELEVATION WHENEVER POSSIBLE.
- 4. ALTERNATIVES SUCH AS HAY BALES OR BRUSH BARRIERS MAY BE SUBSTITUTED IN LIEU OF SILT FENCES, SUBJECT TO APPROVAL OF THE ENGINEER.

TRIM GEOTEXTILE

- 5. TESC FEATURES SHALL BE USED BETWEEN ALL DRAINAGE DITCHES AND ADJACENT SURFACE WATER BODY WHERE THESE DITCHES AREA DOWNSTREAM OF THE OFFLOADING AND TEMPORARY STORAGE AREAS.
- 6. THE CONTRACTOR SHALL KEEP OFF-SITE STREETS THAT ARE IMPACTED AS A RESULT OF THE CONTRACTOR'S WORK CLEAN AT ALL TIMES. FLUSHING STREETS SHALL NOT BE ALLOWED. ALL STREETS SHOULD BE SWEPT USING HIGH
- EFFICIENCY VACUUM SWEEPERS.
- 7. THE TEMPORARY EROSION/SEDIMENT CONTROLS SHALL BE INSTALLED, INSPECTED, AND OPERATING BEFORE ANY EXCAVATION OCCURS. THESE CONTROLS MUST BE SATISFACTORILY MAINTAINED UNTIL CONSTRUCTION ACTIVITIES ARE APPROVED AS COMPLETE BY THE OWNER.

ISSUED FOR CONSTRUCTION





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DESIGNED BY: R. PICKERING DRAWN BY: <u>C. HEWETT</u> CHECKED BY: J. LAPLANTE APPROVED BY: <u>J. LAPLANTE</u> SCALE: AS NOTED DATE: JULY 2015


PORT GAMBLE BAY CLEANUP

C-15

TESC DETAILS

SHEET NO. **25** OF **27**

POPE RESOURCES LP / OPG PROPERTIES LLC

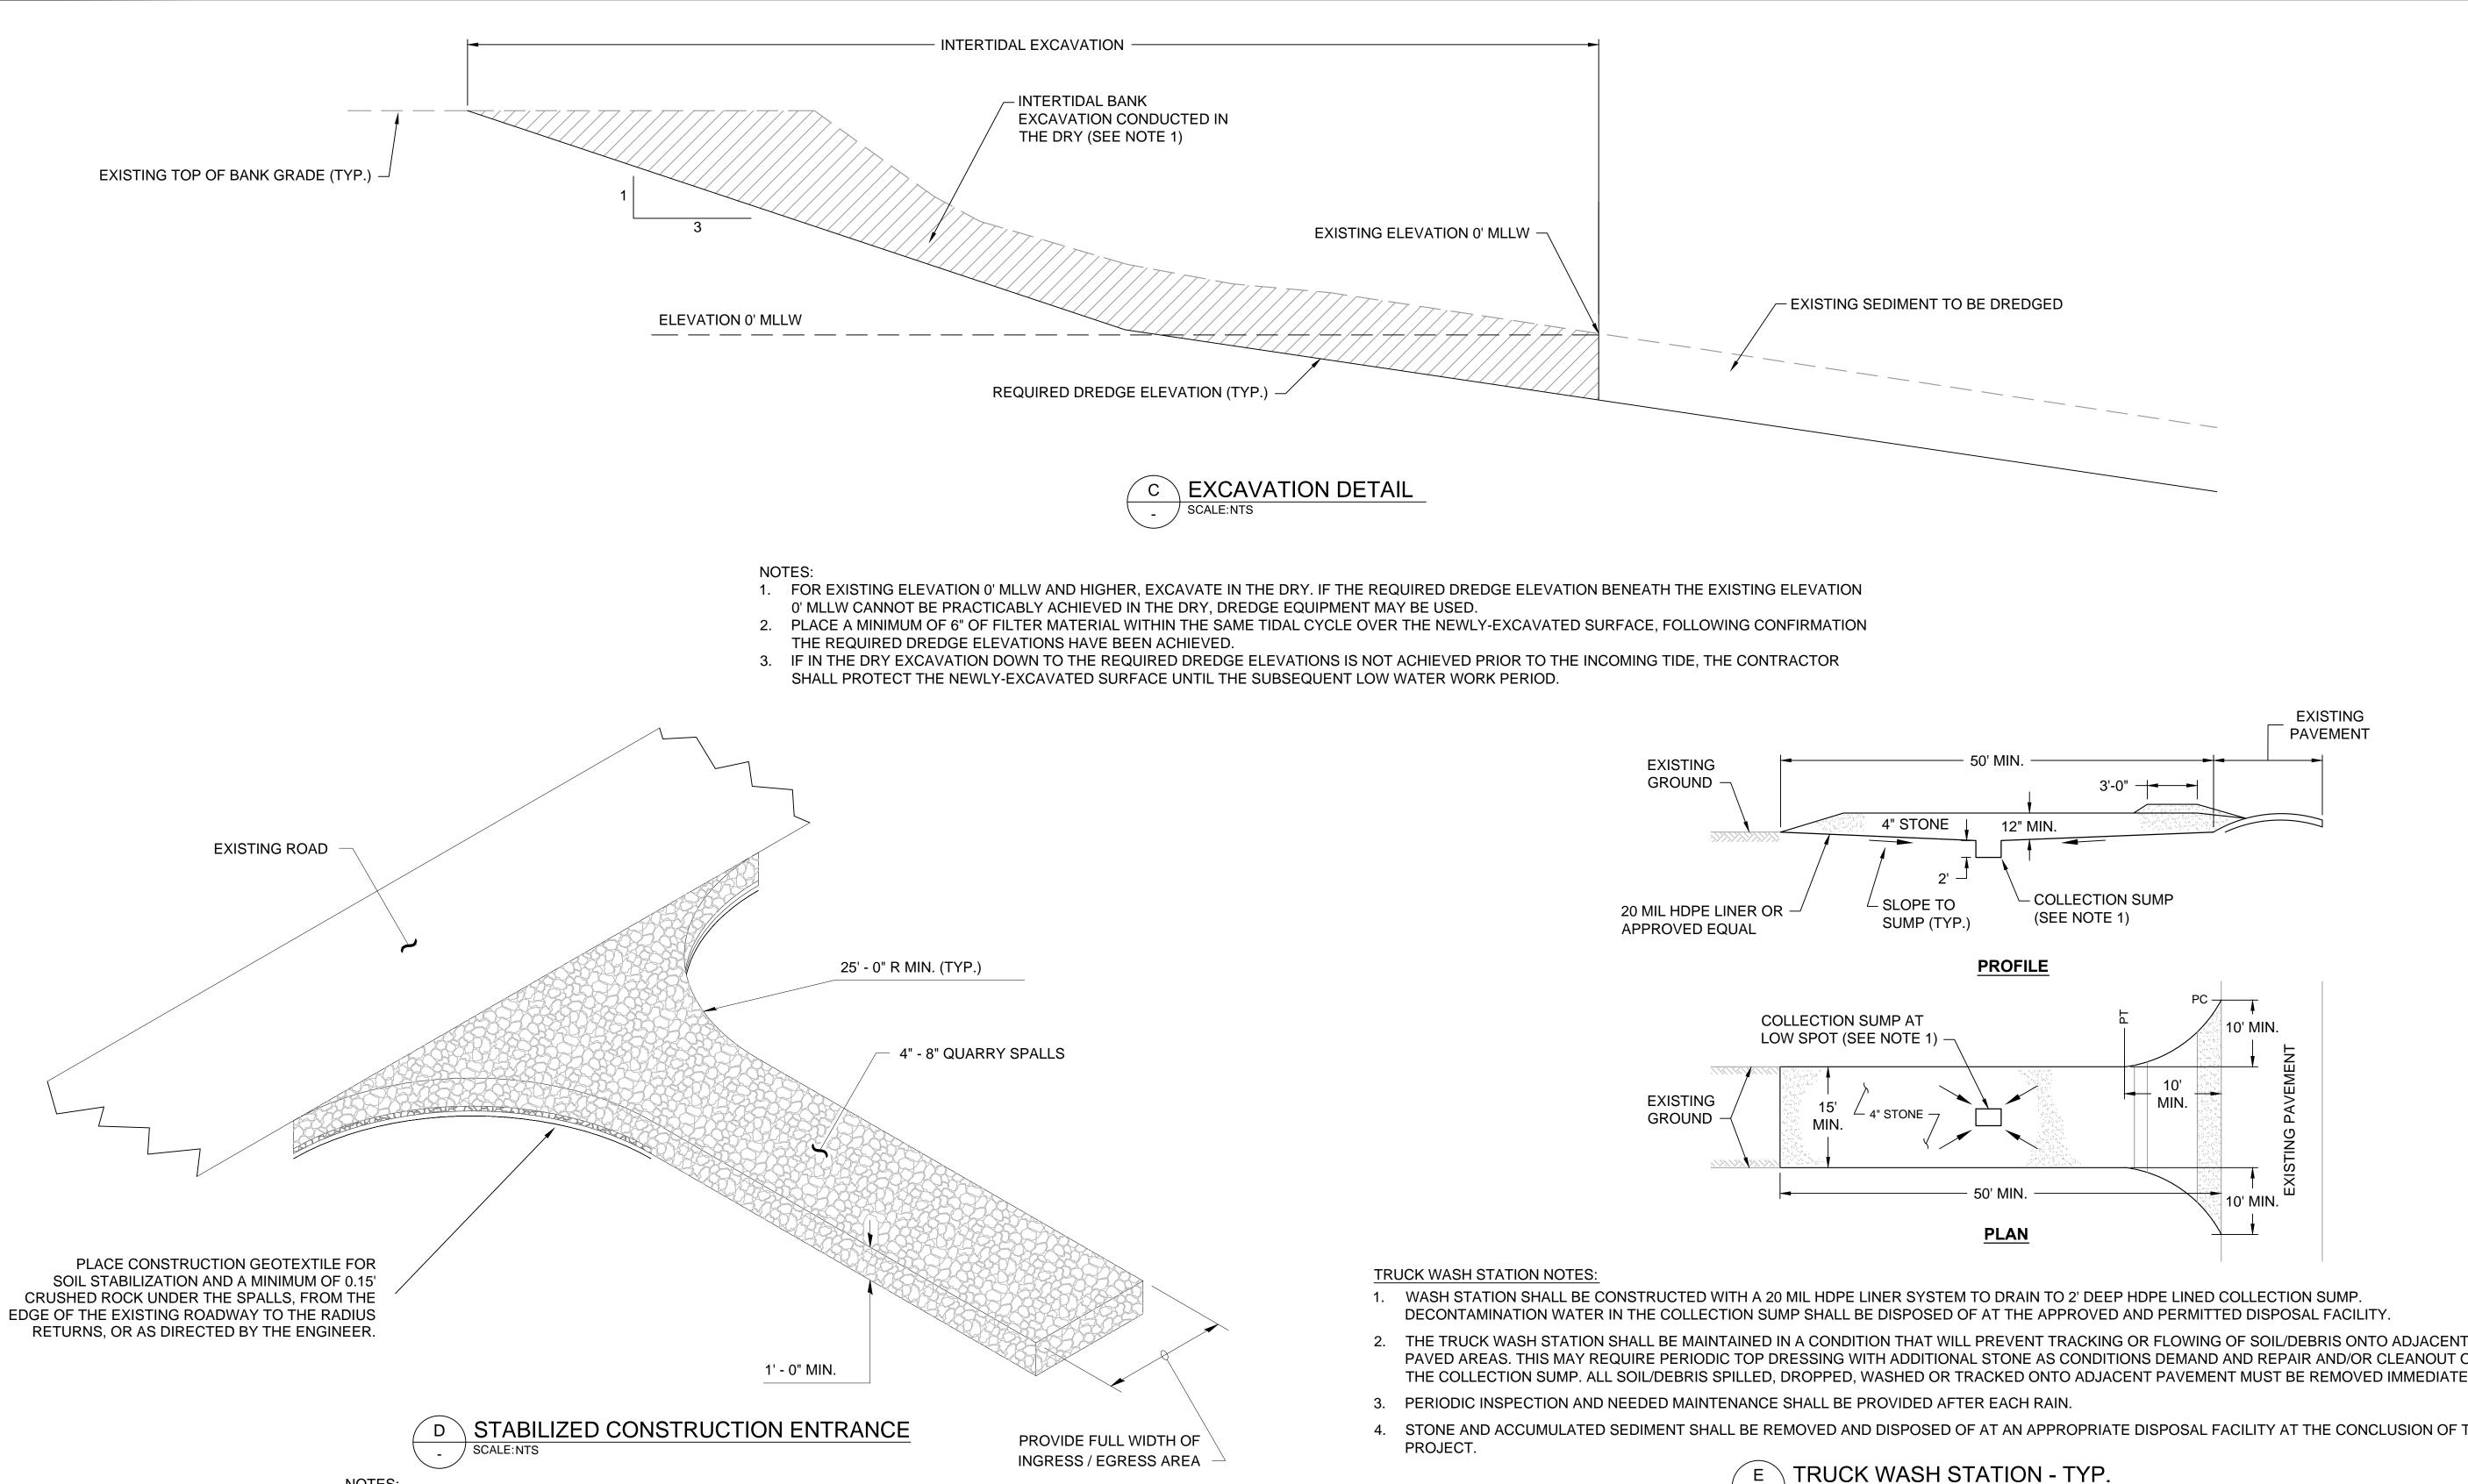

- DECONTAMINATION WATER IN THE COLLECTION SUMP SHALL BE DISPOSED OF AT THE APPROVED AND PERMITTED DISPOSAL FACILITY.
- PAVED AREAS. THIS MAY REQUIRE PERIODIC TOP DRESSING WITH ADDITIONAL STONE AS CONDITIONS DEMAND AND REPAIR AND/OR CLEANOUT OF THE COLLECTION SUMP. ALL SOIL/DEBRIS SPILLED, DROPPED, WASHED OR TRACKED ONTO ADJACENT PAVEMENT MUST BE REMOVED IMMEDIATELY.
- 4. STONE AND ACCUMULATED SEDIMENT SHALL BE REMOVED AND DISPOSED OF AT AN APPROPRIATE DISPOSAL FACILITY AT THE CONCLUSION OF THE




DATE: JULY 2015

ISSUED FOR CONSTRUCTION

POPE RESOURCES LP / OPG PROPERTIES LLC

1. A STABILIZED ENTRANCE, SUCH AS THE DETAIL SHOWN, SHALL BE CONSTRUCTED, IF NECESSARY, AT THE ENGINEER'S DIRECTION TO PREVENT TRACKING OF SOIL ONTO PUBLIC ROADWAYS AND TO PREVENT EROSION AND RUNOFF FROM ACCESS ROUTES.

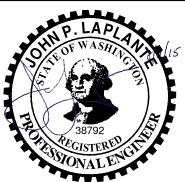

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SIGNED BY: R. PICKERING PORT GAMBLE BAY CLEANUP DRAWN BY: <u>C. HEWETT</u> HECKED BY: J. LAPLANTE

C-16

MISCELLANEOUS DETAILS

PROVED BY: J. LAPLANTE SCALE: AS NOTED

SHEET NO. **26** OF **27**

